THE UNITED REPUBLIC OF TANZANIA



PRESIDENT'S OFFICE REGIONAL ADMINISTRATION AND LOCAL GOVERNMENT

PROPOSED STANDARD DRAWINGS FOR SCHOOL FACILITIES.


Schedule of Materials, Labour & Drawings for Two Classroom with Office Block – Gable

PROJECT AREA

TANZANIA MAINLAND

Ministry of Education, Science and Technology,

Government City - Mtumba, AFYA -Street, P. O. Box 10, **40479 DODOMA.** President's Office, Regional Administration, & Local Government Government City - Mtumba TAMISEMI Street, P. O. Box 1923, 41185 DODOMA.

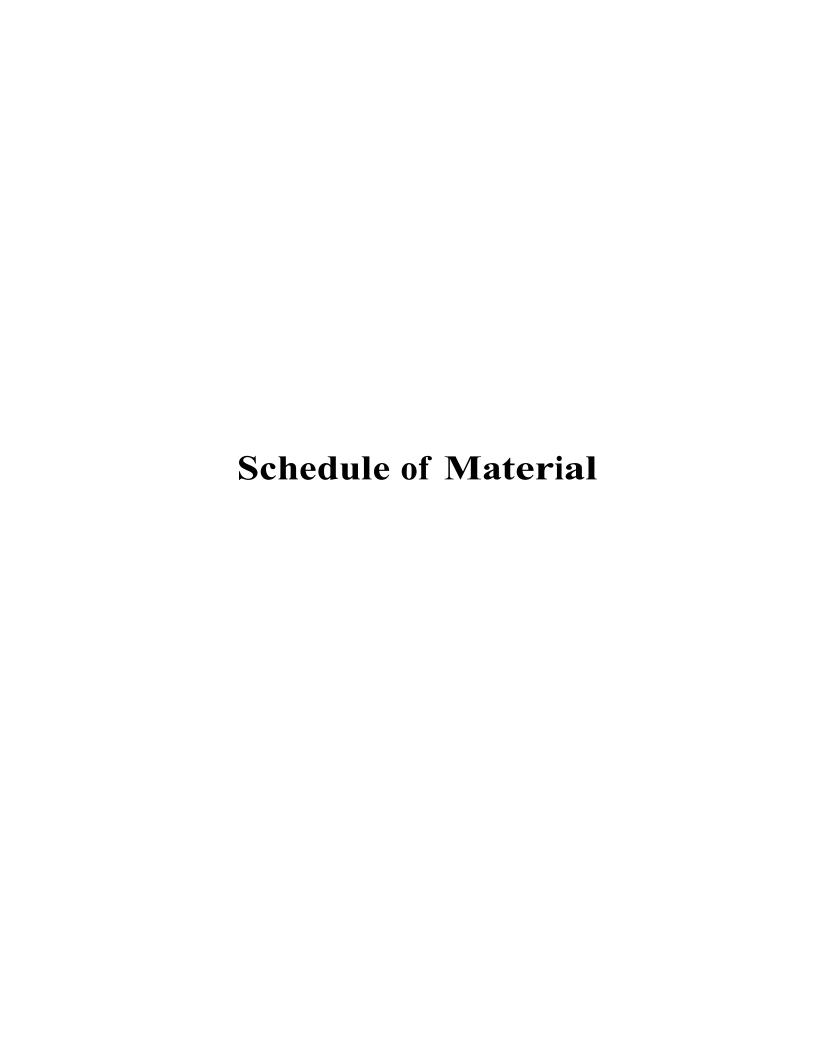

GROSS FLOOR AREA =187 SQ.M

TEM	DESCRIPTION	QTY	UNIT	PRICE-TZS	AMOUNT
	<u>MATERIALS</u>				
Α	SUB-STRUCTURE -PROVISIONAL				
1	Strip Foundation - Grade 15 Plain				
	Aggregate (3/4")	12	M^3		
	Sand		M^3		
	Cement-50kgs (42.5)		Bags		
	osmem congo (1 <u>1</u> 10)				
2	Foundation Walls				
	6" Cement & Sand block - Minimum Strength 3. 5 MPa	1,246	No		
	Sand		M^3		
	Cement -50kgs (42.5)		Bags		
3	Moram, Hardcore & Site sterilization	21	Dags		
	Moram (4.5m ³ lorry)	0	Trino		
			Trips		
	Hardcore 200mm thick - (4.5m ³ lorry)		Trips		
	Sand		M ³		
	Aldrin solution or other and equal approved (1000mls)	2	Bottle		
4	Oversite Concrete 100mm thick - 15 grade ,Ground Beam and base column - 20 grade				
	DPM	186	M^2		
	Cement -50kgs (42.5)		Bags		
	Aggregates (1/2")		M^3		
	Sand		M^3		
	Reinforcement - 12mm diameter high tensile 460N/mm2		PC'S		
	Reinforcement - 8mm diameter high tensile 460N/mm2	40	PC'S		
	Binding Wire - 25kg	10	Kg		
	Timber 1" X 10 " (5.2m long)		PC'S		
	Timber 2" X 2"	10	PC'S		
	Nails-4"		Kgs		
	Nails-3"	13	Kgs		
	Supporting props	12	PC'S		
	SUB-TOTAL SUBSTRUCTURE				
B.	<u>SUPERSTRUCTURE</u>				
1	Walls Ring beam & Columns				
	6" Cement & Sand block - Minimum Strength 3. 5 MPa - 230mm	2,380	No		
	6" Cement & Sand block - Minimum Strength 3. 5 MPa- 150mm	396	No		
	DPC 25m		Roll		
	Sand	12	M^3		
			D		
	Cement-50kgs (42.5)	93	Bags		
	Aggregates (1/2")	4	M^3		
	Aggregates (1/2") Reinforcement - 12mm diameter high tensile 460N/mm2	4 30	M ³ PC'S		
	Aggregates (1/2")	4 30 31	M ³ PC'S PC'S		
	Aggregates (1/2") Reinforcement - 12mm diameter high tensile 460N/mm2 Reinforcement - 8mm diameter high tensile 460N/mm2 Binding Wire - 25kg	4 30 31 10	M ³ PC'S PC'S Kg		
	Aggregates (1/2") Reinforcement - 12mm diameter high tensile 460N/mm2 Reinforcement - 8mm diameter high tensile 460N/mm2	4 30 31 10 17	M ³ PC'S PC'S Kg PC'S		
	Aggregates (1/2") Reinforcement - 12mm diameter high tensile 460N/mm2 Reinforcement - 8mm diameter high tensile 460N/mm2 Binding Wire - 25kg Timber 1" X 10" to Sides (5.2m long) Timber 1" X 5" (Plates)	4 30 31 10 17 5	M³ PC'S PC'S Kg PC'S PC'S		
	Aggregates (1/2") Reinforcement - 12mm diameter high tensile 460N/mm2 Reinforcement - 8mm diameter high tensile 460N/mm2 Binding Wire - 25kg Timber 1" X 10" to Sides (5.2m long)	4 30 31 10 17 5	M ³ PC'S PC'S Kg PC'S		

TEM	DESCRIPTION	QTY	UNIT	PRICE-TZS	AMOUNT
ı Lıvı	DESCRIPTION	QII	CIVII	FRICE-123	AWIOUNI
C.	ROOF STRUCTURE & COVERING				
1	Roof Structure - Provisional				
	Timber 2 " X 3" Purlins	57	PC'S		
	Timber 2" X 4" King Post, wall plate and struts	80	PC'S		
	Timber 2" X 6" Rafter and Tie beam	68	PC'S		
	Fascia board 1" X 10" -ref. Semi Hardwood (5.2m long)	15	PC'S		
	Nails -5"	45	Kgs		
	Nails -4"		Kgs		
	Nails -3"		Kgs		
	16mm diameter bolt		Pc's		
	NOTE: The above softwood timber structure should be pressure impregnated treated				
2	Roof Covering				
	28G IT5 resin coated sheet size 3000x900mm	120	PC'S		
	Hips/Ridge and valley - 28 G IT resin coated		PC'S		
	Roofing Nails	27	Packet		
3	Gutter's				
	Upvc 100mm half round (6m long)-5"	12	PC'S		
	Upvc 75mm diameter down pipe; Class B		PC'S		
	PVC outlet		PC'S		
	PVC bend 90'		PC'S		
	PVC bend 45'		PC'S		
	Gutter support bracket		PC'S		
	Gutter Clamp 3"		PC'S		
	Connector/reducer		PC'S		
	Connector outer		PC'S		
	Corner Inner		PC'S		
	Water storage tank; 5000 litres capacity with dust and insect proof lid; 20mm 3Nr tank connectors; 25mm 1Nr wash - out tank connector; 20mm high pressure ball float operated stop valve; all connections to IPS	2	PC'S		
	SUB-TOTAL ROOF STRUCTURE & COVERING				
D.	CEILING				
	Gypsum board -9mm thick		PC'S		
	Plain Cornice (8ft)	53	PC'S		
	Screw 1.25" 500pcs/box	3	Box		
	Gypsum powder	12	Bags		
	Fiber tape (90m)		Roller		
	Treated softwood Timber 2" X 2"	122	PC'S		
	Nails 4"	14	Kgs		
	Nails 3"	20	Kgs		
	SUB-TOTAL FOR CEILING			-	

CHE	DULE OF MATERIALS TWO CLASSROOM BLOCK WITH OFFICE			GROSS F	LOOR AREA =187
TEM	DESCRIPTION	QTY	UNIT	PRICE-TZS	AMOUNT
E.	DOOR				
1	40mm thick hardwood Matchboarded door shutter				
	820 x 2100mm high	3	PC'S		
2	45 x 145mm Frames (hardwood) & Varnish				
	900 x 2500 mm high door frame	3	PC'S		
	5mm thick clear glass to Vents		m2		
	16mm diametere burglar bars -1100mm long		Pcs		
	Brush 3"		Pcs		
	Sand paper (msasa) No.80		LM		
	Clear Varnish - 4Litres		TIN		
	Thinner for Varnish		Litres		
	THIRDE TO VAITISH		Lilles		
3	Ironmongeries - ref. Union				
	Mortice lock Three lever	3	No		
	Brass butt hinges - 100mm	4.5	Pairs		
	SUB-TOTAL FOR DOORS				
F.	WINDOWS				
4	Alternative all discountries				
1	Aluminium sliding Window comprising 100mm x 1.2mm thick				
	standard aluminium profile ex-china/Turkey infill with 5mm				
	thick glass complete with mosquito proofing panel, including				
	all accessories, ironmongeries, cutting and pinning lugs				
	1500 X 1500mm high		PC'S		
	1100 X 1500mm high	1	PC'S		
2	25 x 4mm thick flat bar grill painted red-oxide with 25 x 25mm				
	square pipes frame and all necessary accessories				
	1500 X 1500mm high	1	PC'S		
	1100 X 1500mm high	1	PC'S		
	SUB-TOTAL FOR WINDOWS				
G.	<u>FINISHING</u>				
1	Floor finishing				
	Bedding/Backing; cement sand and Chipping (1:2:2); to steel				
	<u>finishing</u>				
	40mm Thick granolithic floor screed steel toweling to smooth				
	finishing		_		
	Sand		M ³		
	Cement-50kgs (42.5)		Bags		
	Chipping		M^3		
	2mm thick plastic Strips	233	M		
2	Wall Finishing-15mm thick (1:4)				
	Sand	13	М3		
	Cement-50kgs (42.5)		Bags		
	Sand paper (msasa) No.120	11			
	White cement - 40kg		Bags		
	Gypsum powder		Bags		
	SUB-TOTAL FOR FINISHING				

SCHE	DULE OF MATERIALS TWO CLASSROOM BLOCK WITH OFFICE			GROSS I	FLOOR AREA =187 SQ
ITEM	DESCRIPTION	QTY	UNIT	PRICE-TZS	AMOUNT
Н.	PAINTING & DECORATION				
	Emulsion Paint - 20 LTRS	9	buckets		
	Weather guard Paint - 20 LTRS	3	buckets		
	Washable paint -20 LTRS	4	buckets		
	Primer paint -20 LTRS	2	buckets		
	Solvent - 5LTRS	2	TIN		
	Brush 3"	4	Pcs		
	Roller	4	Pcs		
	Gloss paint-4LTR	3	TIN		
	Bitumen paint - 4Litres		TIN		
	SUB-TOTAL FOR PAINTING&DECORATION				
J.	BALUSTERS & HANDRAIL				
	Supply and fix steel balustrade overall height 900mm high,				
	comprising 50mm diameter hollow section mild steel pipe top and				
	bottom rail, 38mm diameter intermediate rails, 50mm diameter				
	vertical rails 900mm high spaced at interval of 450mm centres				
	to centres including all bolts, plates and associated accessories				
	and welded works, red oxed and painted as per				
	architectural drawing to the aproval of Project Surpervisor.	18	m		
	SUB-TOTAL BALUSTERS & HANDRAIL				
K.	ELECTRICAL INSTALLATION				
	Single fluorescent fitting Complete,LED philips or other equal approved	22	No		
	Double switch socket ABB or other equal approved	8	No		
	Main switch 6way,1PH with integral RCD 100A/300mmA ABB other equal approved	1	No		
	NB: Cables for 1.5sqmm 2.5sqmm and 4sqmm should be EURO or other equal approved				
	Single core wire 1.5sqmm - Red	2	Roll		
	Single core wire 1.5sqmm - Black	2	Roll		
	Single core wire 1.5sqmm -green	2	Roll		
	Single core wire 2.5sqmm - red		Roll		
	Single core wire 2.5sqmm	1	Roll		
	Single core wire 2.5sqmm green		Roll		
	Ceiling fan National or other equal approved		PC's		
	3gang 1 way switch ABB or other equal approved		No		
	2gang 1 way switch ABB or other equal approved		No		
	Earth rod approved copper 16mm not less than 1200mm		No		
	Earth wire 4sqmm	20			
	Metal box twin		No		
	Metal box single		No		
	Junction box		No		
	Conduit pipe		PC's		
	Elbow		PC's		
	Conduit coupling		PC's		
	Round cover		PC's		
	Round box		PC's		
	Fine screw		PACKE	Т	
			BOX	I	
	plastic clips 22mm Bulk head light fitting		PCS		
		4	-03		
	ELECTRICAL INSTALLATION				

	SUMMARY				AMOUNT
					TZS
	2NO. CLASSROOM BLOCK WITH OFFICE				
	OUR OTRUCTURE PROVIDINAL				
Α.	SUB-STRUCTURE -PROVISIONAL				
В.	SUPERSTRUCTURE				
υ.	SOI ENSTRUCTORE				
C.	ROOF STRUCTURE & COVERING				
D.	CEILING				
E.	DOOR				
_	WINDOWS				
F.	WINDOWS				
G.	FINISHING				
<u> </u>	T IIIIOTIIII C				
Н.	PAINTING & DECORATION				
J.	BALUSTERS & HANDRAILS				
K.	ELECTRICAL INSTALLATION				
	TOTAL BUILDING MATERIALS CARRIED TO GENERAL SUMMARY				
	TO THE BOILDING MATERIALS OF MATERIALS TO SERVE OF MINIMARK				
	ADD:				
	LABOUR COST CARRIED TO GENERAL SUMMARY: (Improve and Fill	the respe	ective Lab	oour form)	
	Note:				
	i. Refer attached specification and number of Furniture(s) for two cla	ssroom	with offi	ice Block	
	ii. Refer General Summary for: Preliminary, Transportation and Super	ervision	Costs		
	iii. Preliminary cover the following item:				
	- Setting out working tools, Equipments, Temporary toilets, water fo				
	- Power for the works, Security, store, Materials test, levelling, hold	lings an	d remov	al of rubbish.	
	iv. Supervision cost depend on guideline of the specific project				
	v. Installation of Ceiling Fan is an option, depend on whether conditi	on of sp	ecific ar	ea .	

THE UNITED REPUBLIC OF TANZANIA


MINISTRY OF EDUCATION SCIENCE AND TECHNOLOGY


IN COLLABORATIONS WITH

PRESIDENT'S OFFICE, REGIONAL ADMINISTRATION AND LOCAL GOVERNMENT

PROVISION OF PHYSICAL FACILITIES IN PRIMARY SCHOOLS

Ministry of Education, Science and Technology Government City-Mtumba, Afya Street, P.O. Box 10, 40479 DODOMA President's Office, Regional Administration and Local Government. Government City-Mtumba, TAMISEMI Street, P.O. Box 1923, 41185 DODOMA

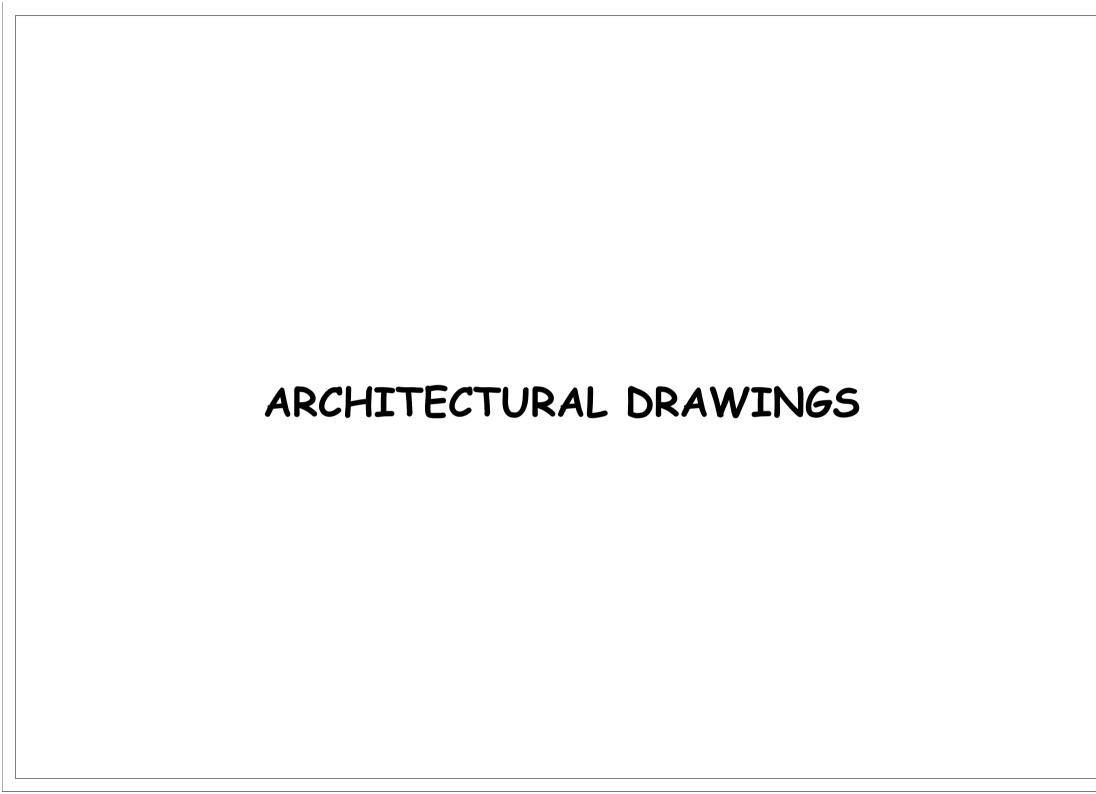

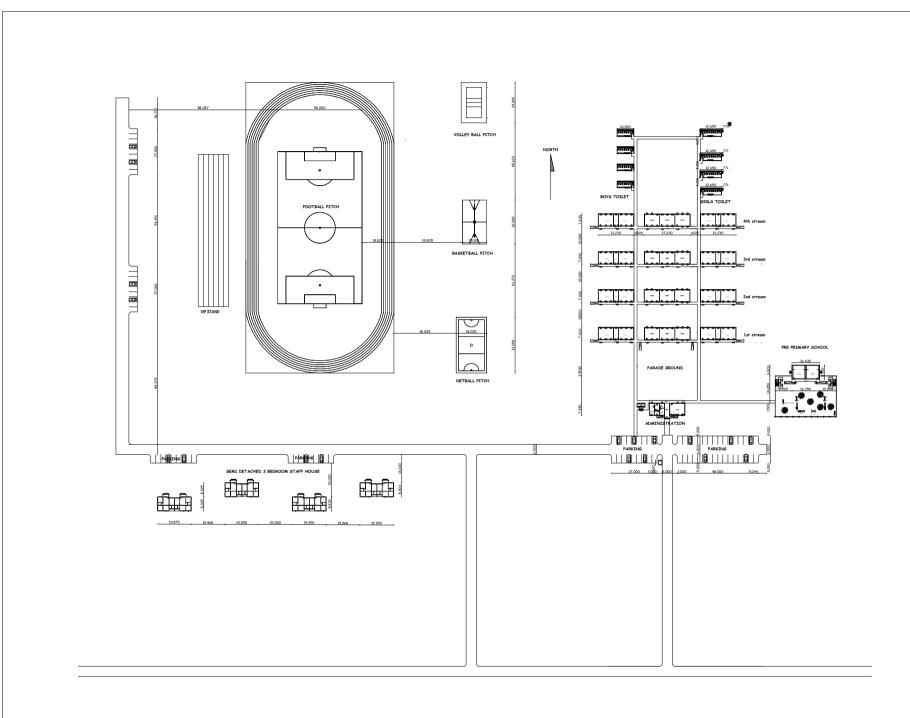



MINISTRY OF EDUCATION, SCIENCE AND TECHNOLOGY
PRESIDENT'S OFFICE REGIONAL ADMINISTRATION AND
LOCAL GOVERNMENT


PROVISIO OF PHYSICAL FACILITIES IN PRIMARY SCHOOLS

PROPOSED STANDARD DESIGN FOR PRE PRIMARY SCHOOL CLASSROOMS

DRAWING TITLE:	Date	December, 2022
SAMPLE SITE PLAN	Drawn by	IA5
	Checked by	AAL
DRAWING NO: ARC/PPS/01	Scale	To fit

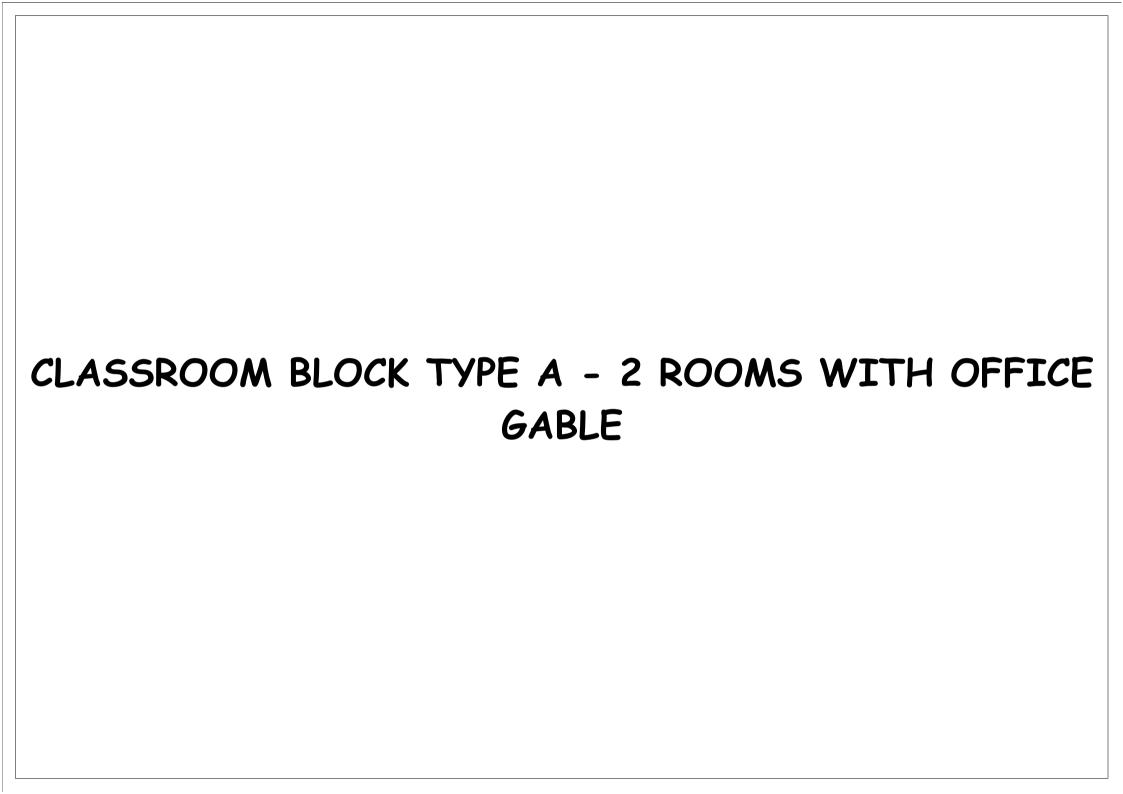

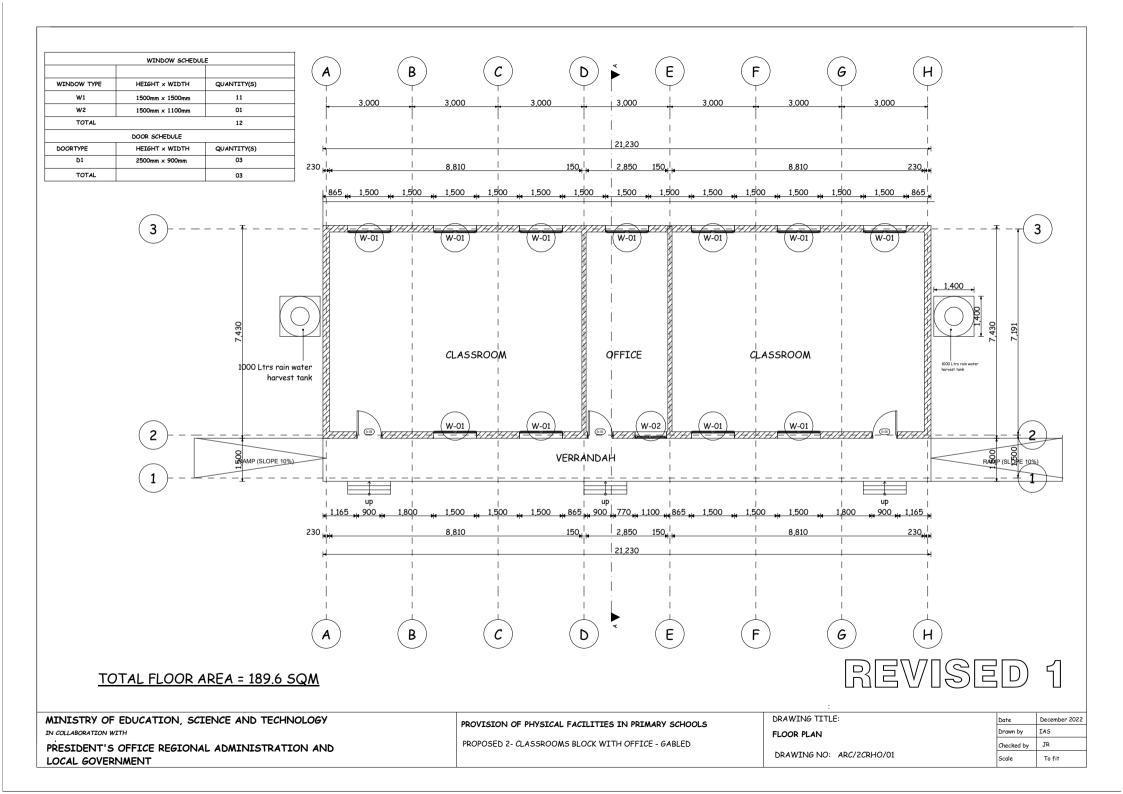

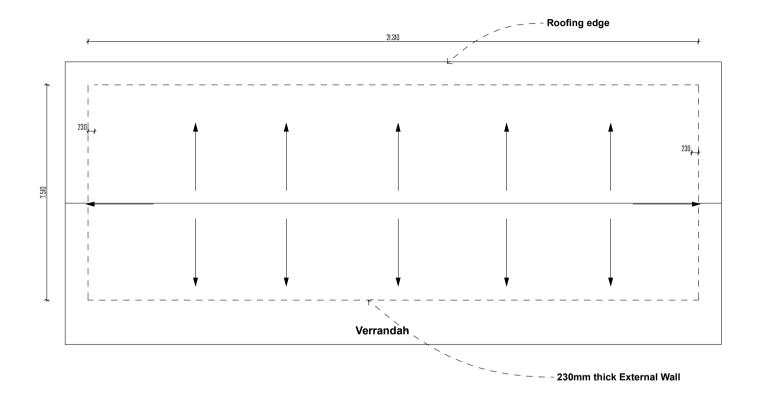

REVISED 1

MINISTRY OF EDUCATION, SCIENCE AND TECHNOLOGY IN COLLABORATION WITH

PRESIDENT'S OFFICE REGIONAL ADMINISTRATION AND LOCAL GOVERNMENT

PROVISION OF PHYSICAL FACILITIES IN PRIMARY SCHOOLS


PROPOSED 2- CLASSROOMS BLOCK WITH OFFICE - GABLED

DRAWING TITLE:

ROOF PLAN

DRAWING NO: ARC/2CRHO/02

Date	December 2022
Drawn by	IAS
Checked by	JR
Scale	To fit

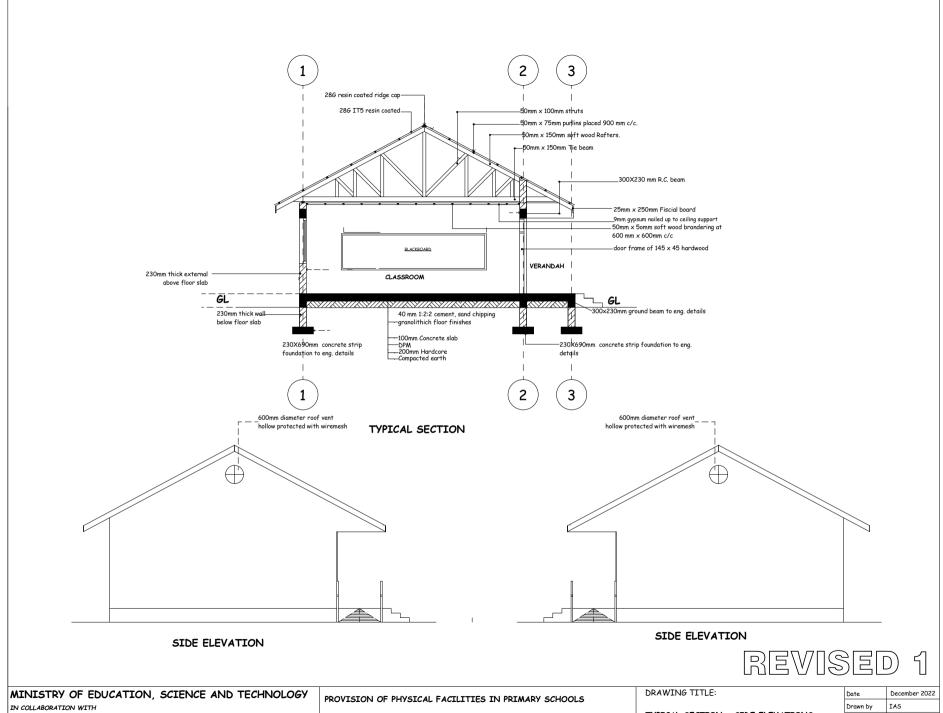


PRESIDENT'S OFFICE REGIONAL ADMINISTRATION AND LOCAL GOVERNMENT


PROPOSED 2- CLASSROOMS BLOCK WITH OFFICE - GABLED

TYPICAL SECTION - SIDE ELEVATIONS
DRAWING NO: ARC/3CRG/03

Date	December 2022
Drawn by	IAS
Checked by	JR
Scale	To fit

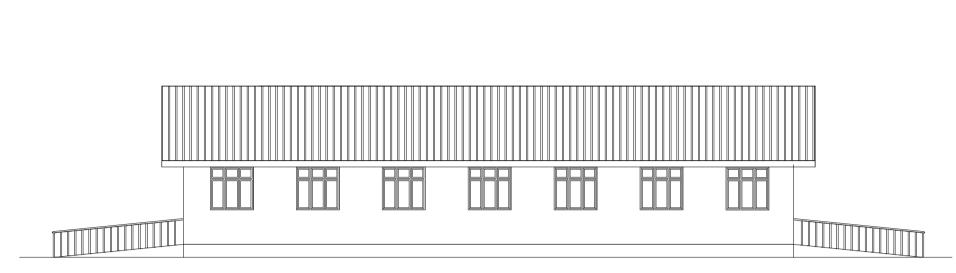

REAR ELEVATION

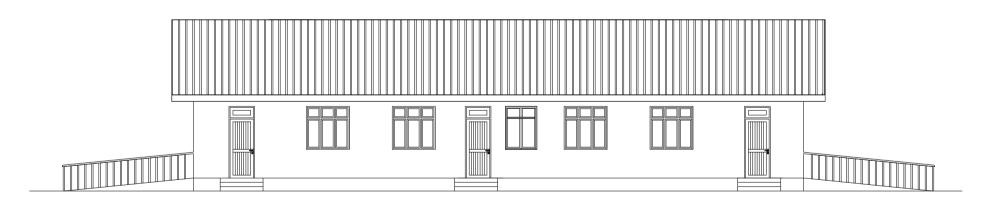

FRONT ELEVATION

REVISED 1

MINISTRY OF EDUCATION, SCIENCE AND TECHNOLOGY IN COLLABORATION WITH

PRESIDENT'S OFFICE REGIONAL ADMINISTRATION AND LOCAL GOVERNMENT

PROVISION OF PHYSICAL FACILITIES IN PRIMARY SCHOOLS

PROPOSED 2- CLASSROOMS BLOCK WITH OFFICE - GABLED

DRAWING TITLE:

FRONT & REAR ELEVATIONS

DRAWING NO: ARC/2CRHO/04

 Date
 December 2022

 Drawn by
 IAS


 Checked by
 JR


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 To fit


STRUCTURAL DRAWINGS


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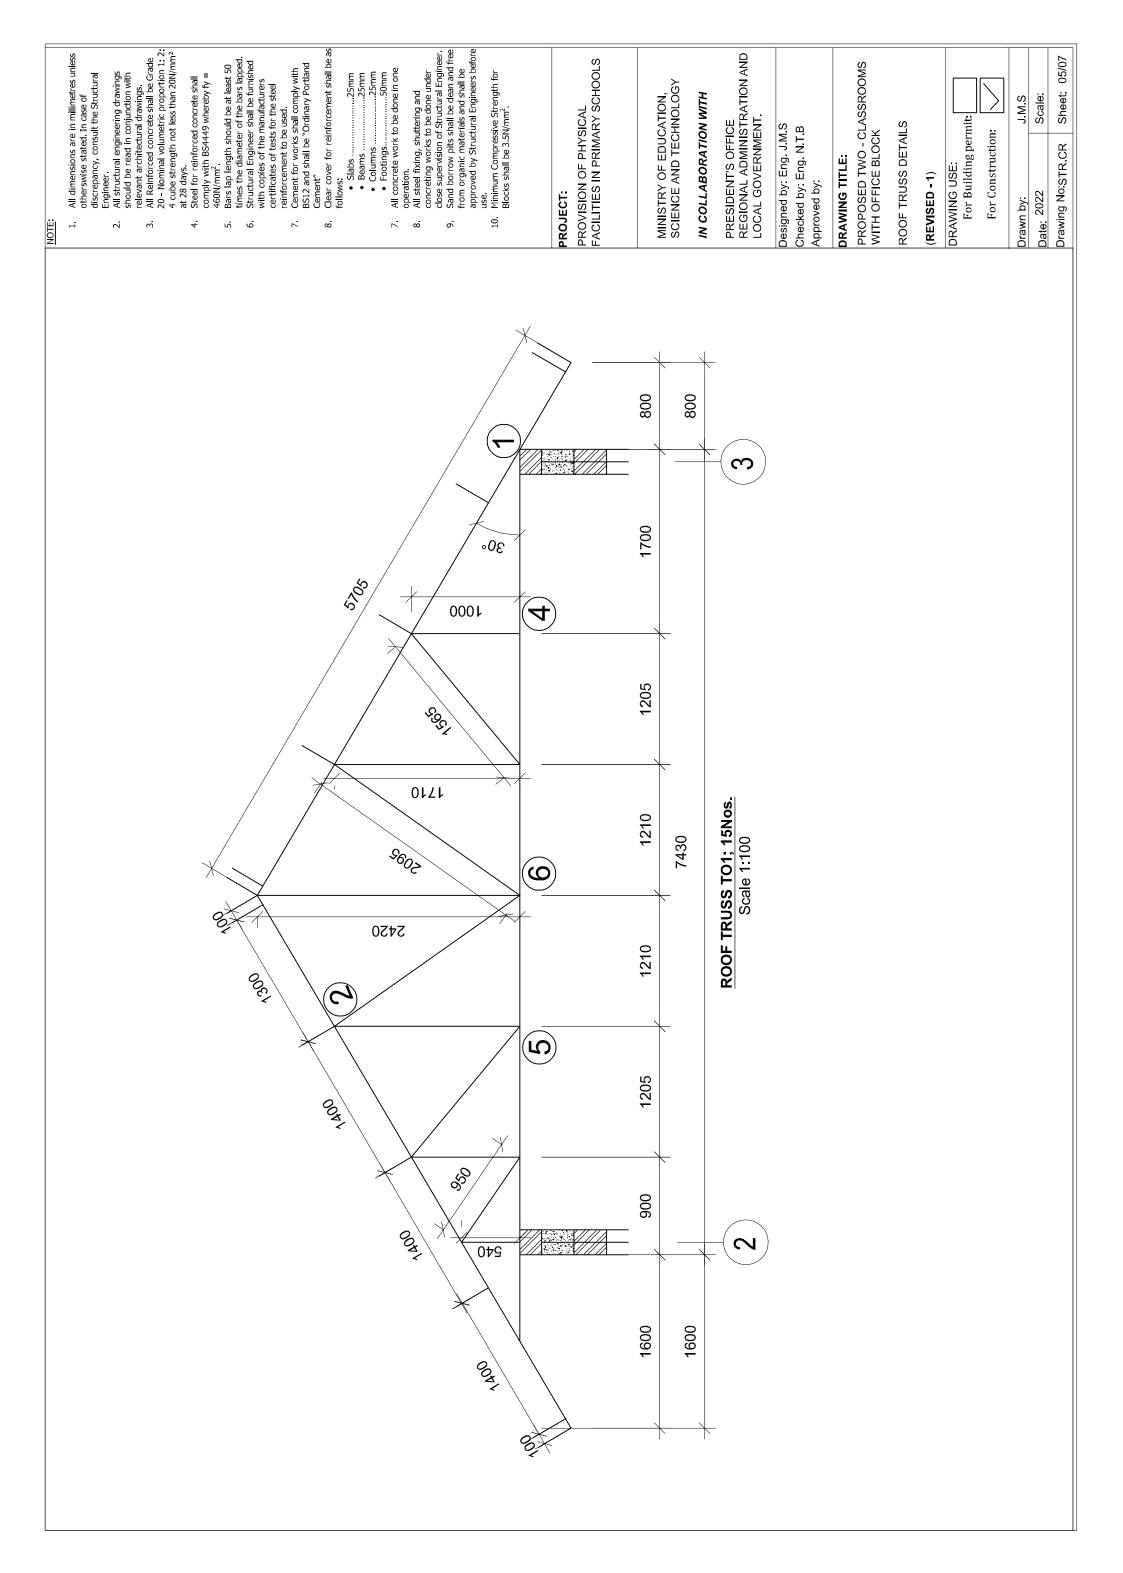
ASSROOM WITH OFFICE BLOCK TYPE A - 2 ROOMS - GABLE




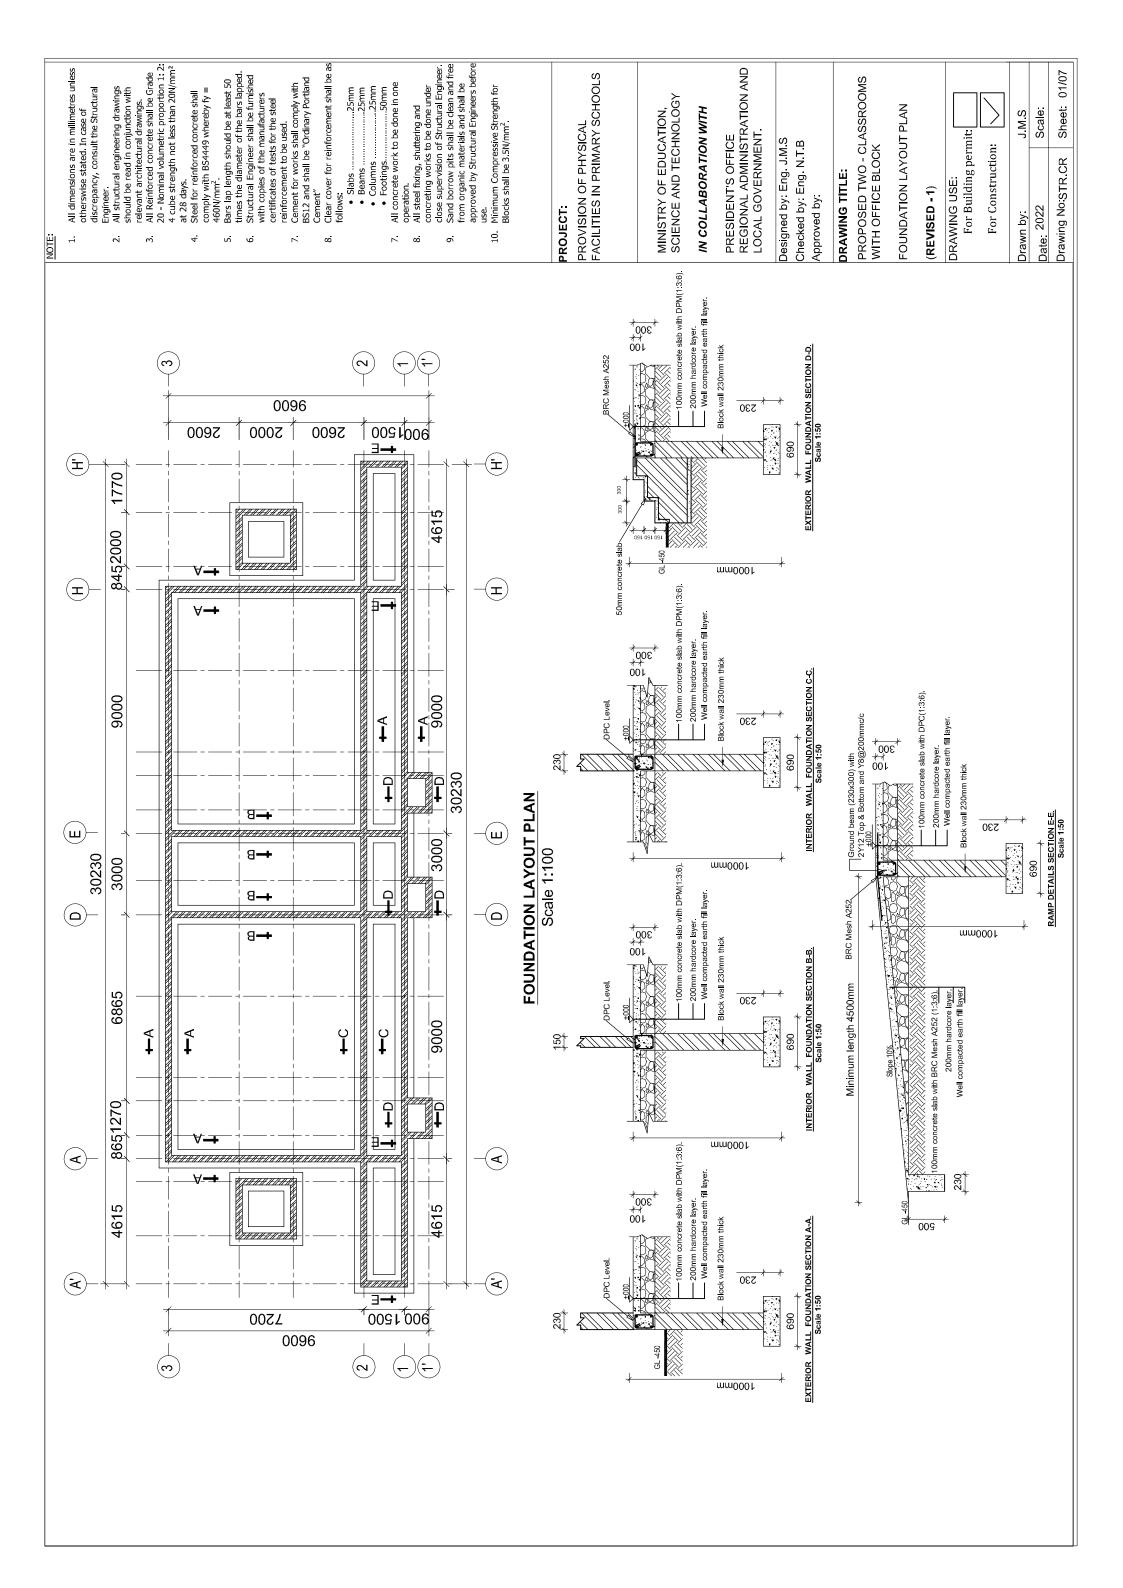

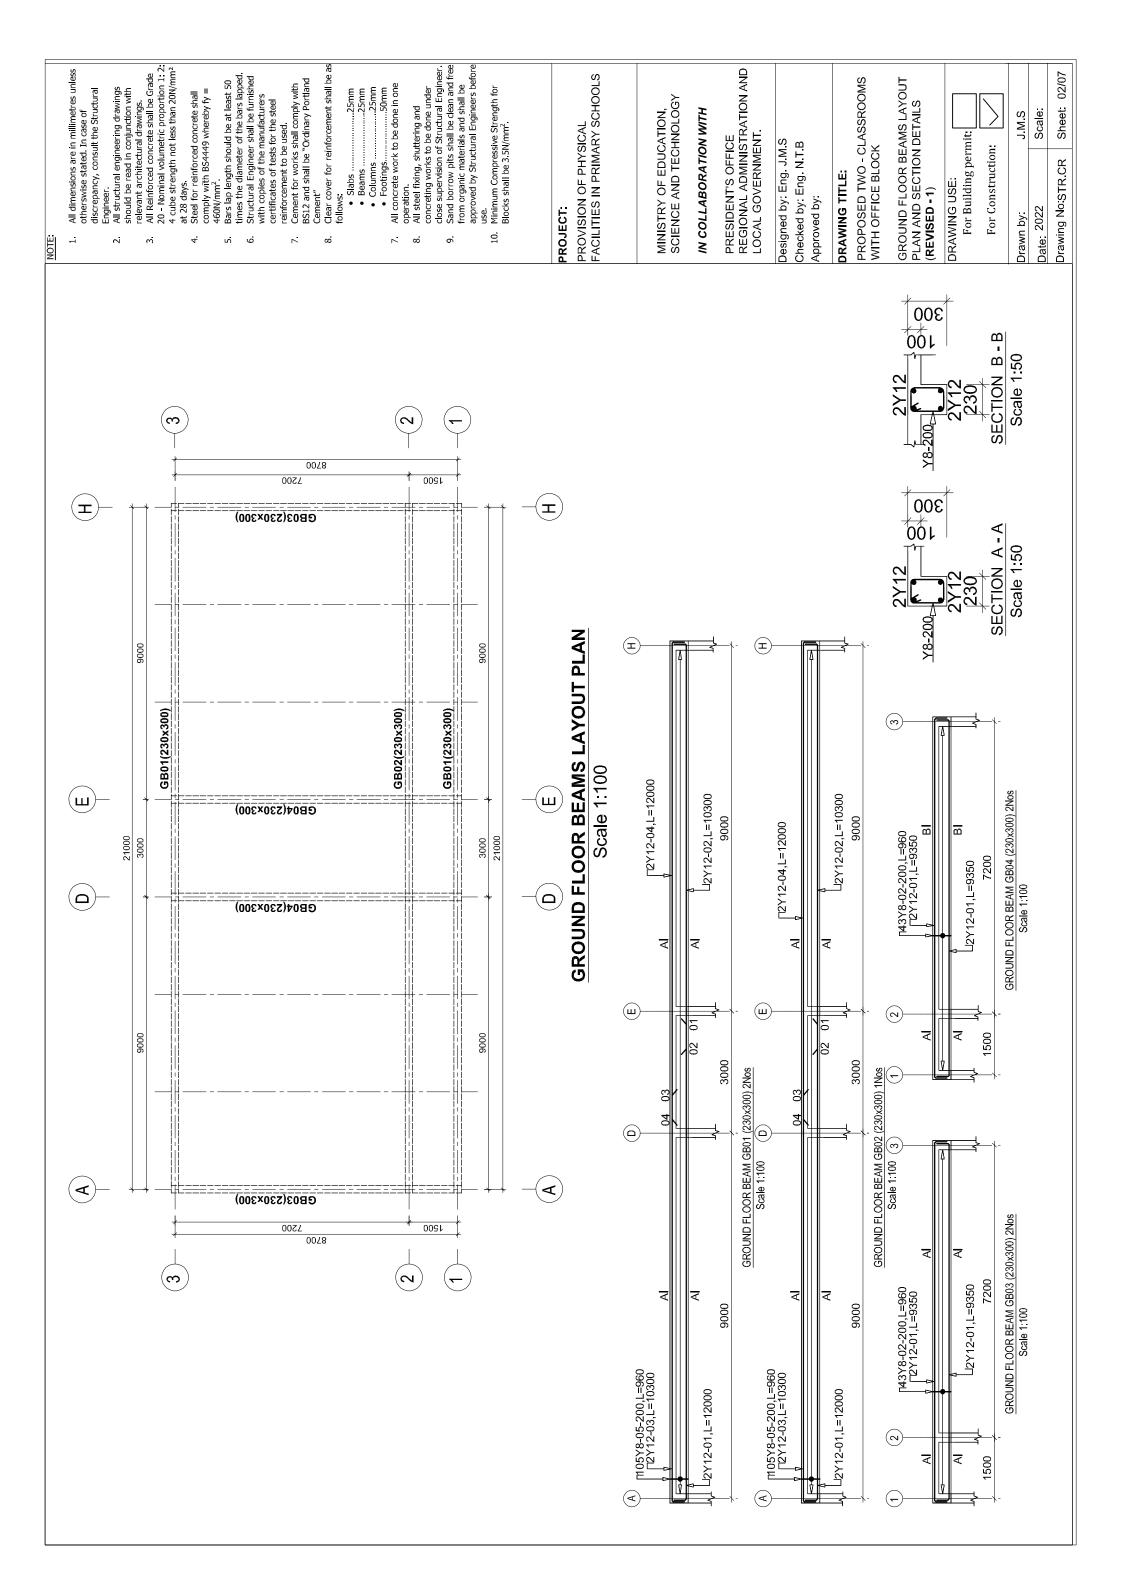

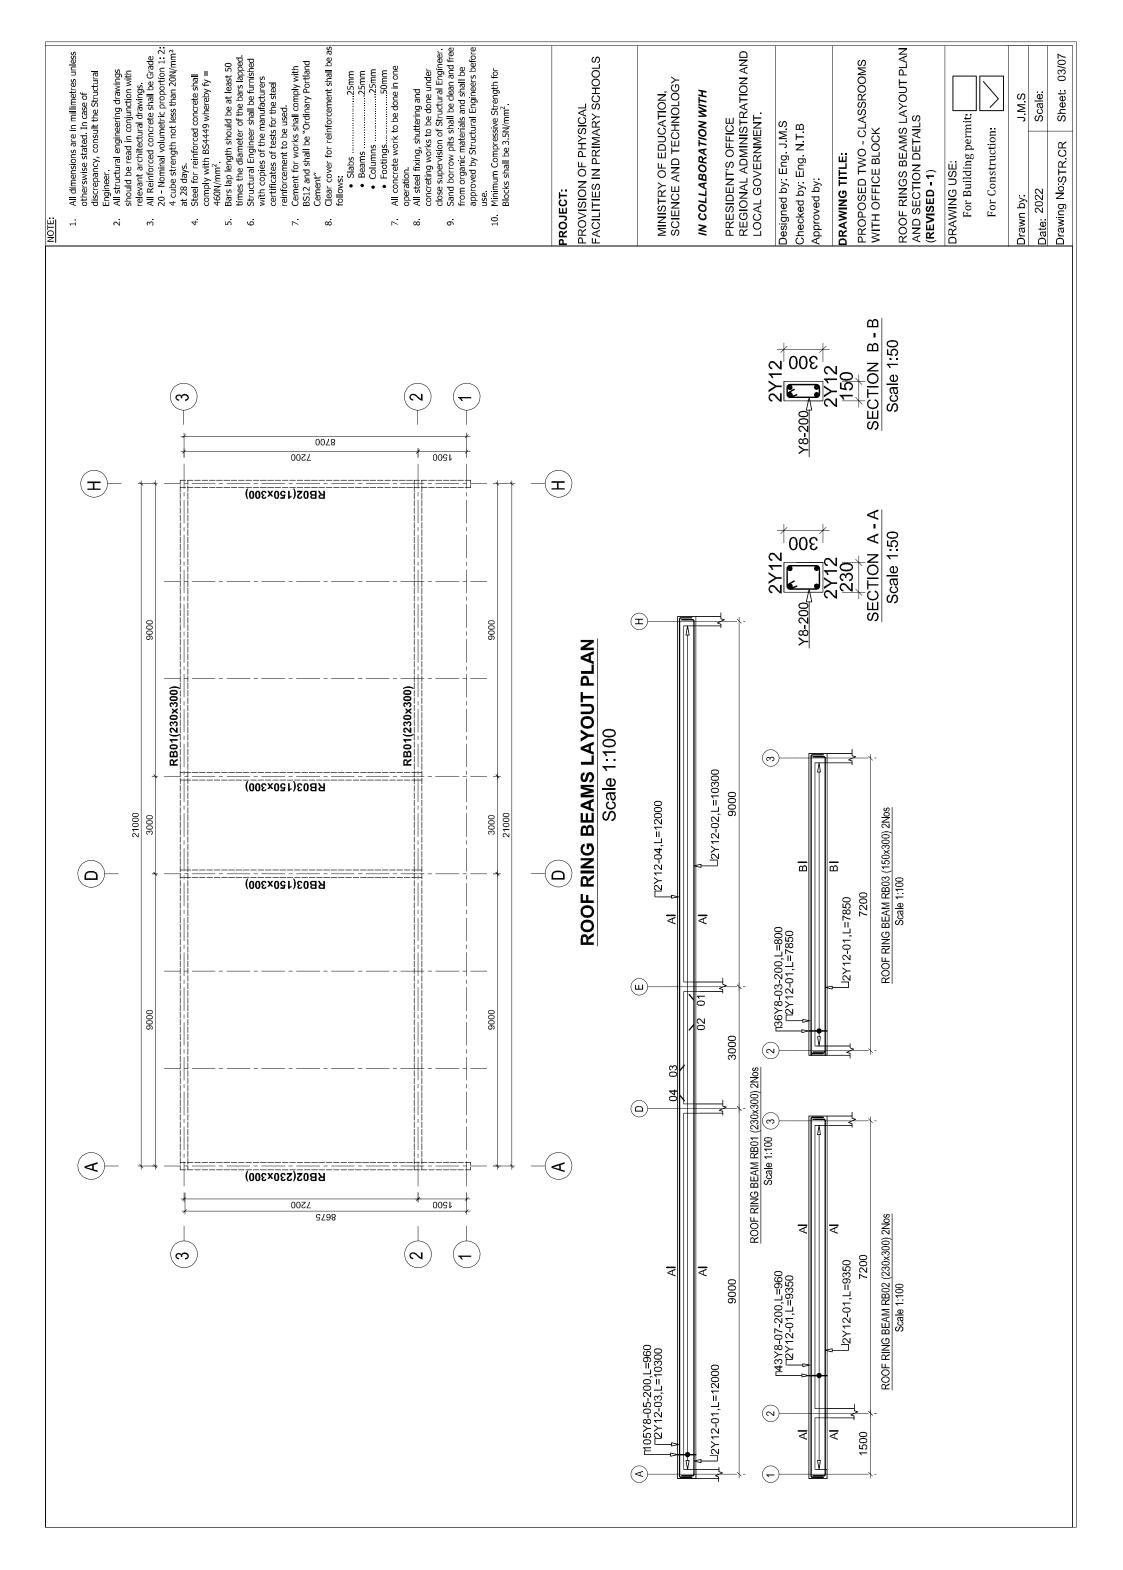

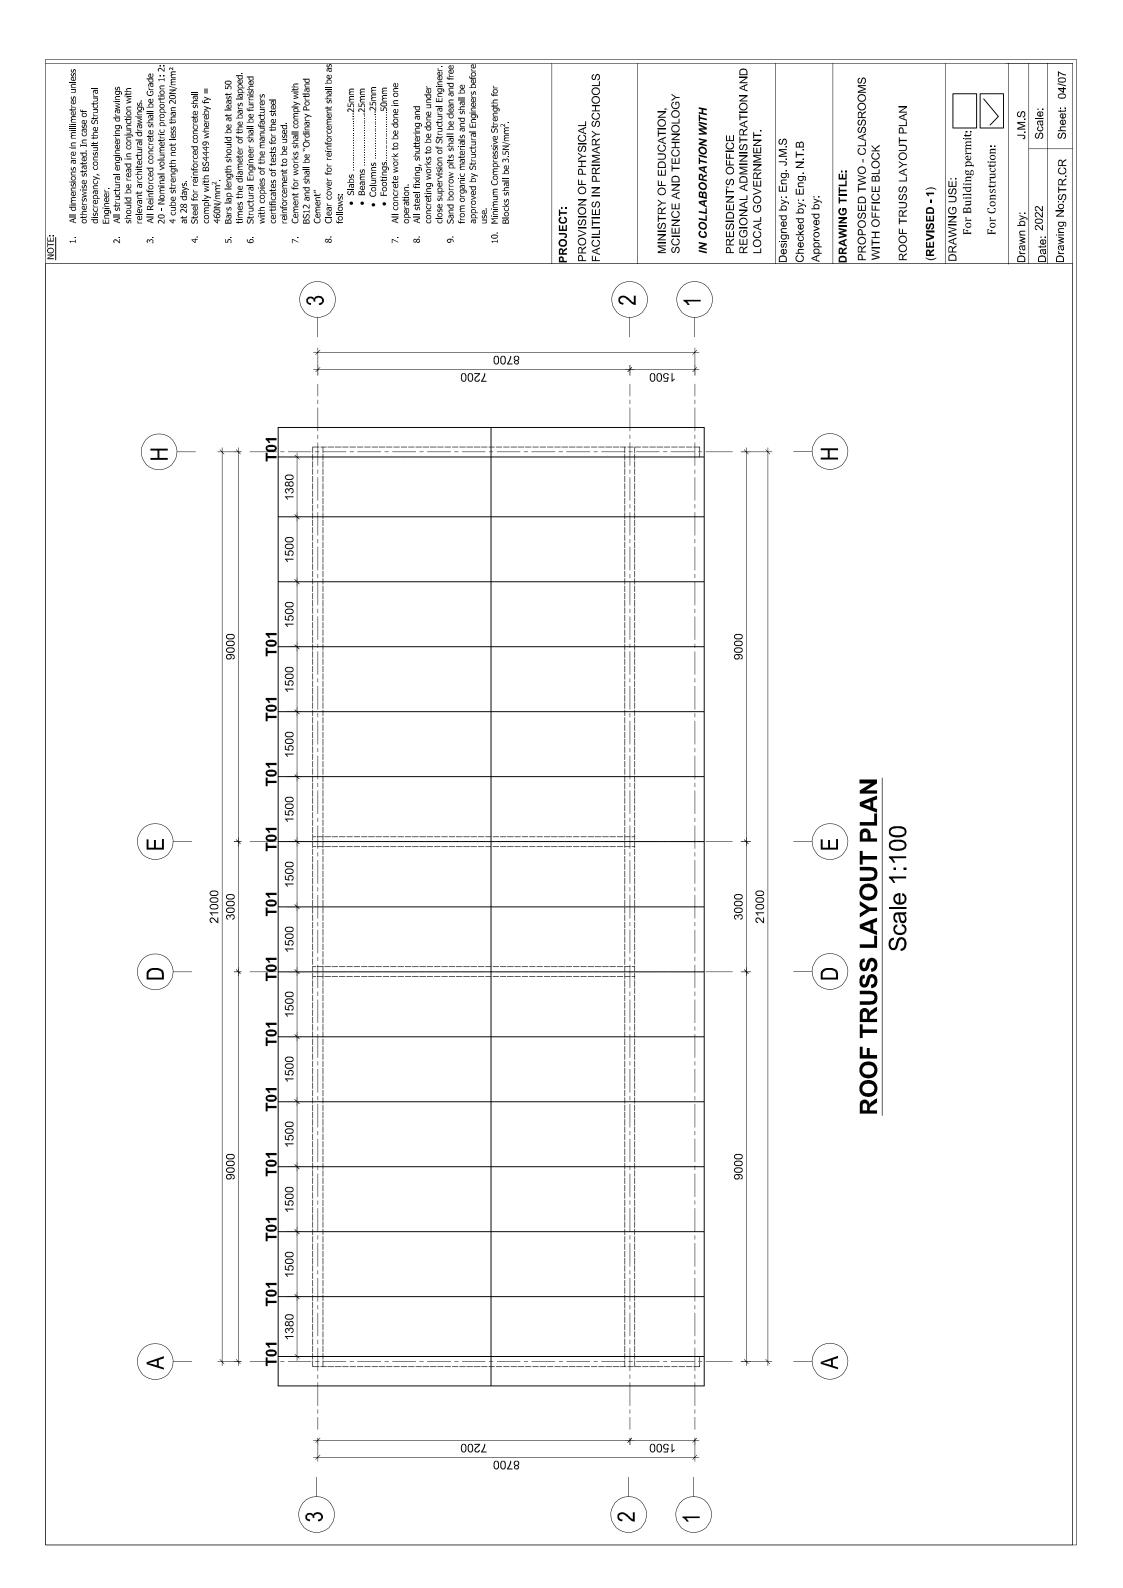

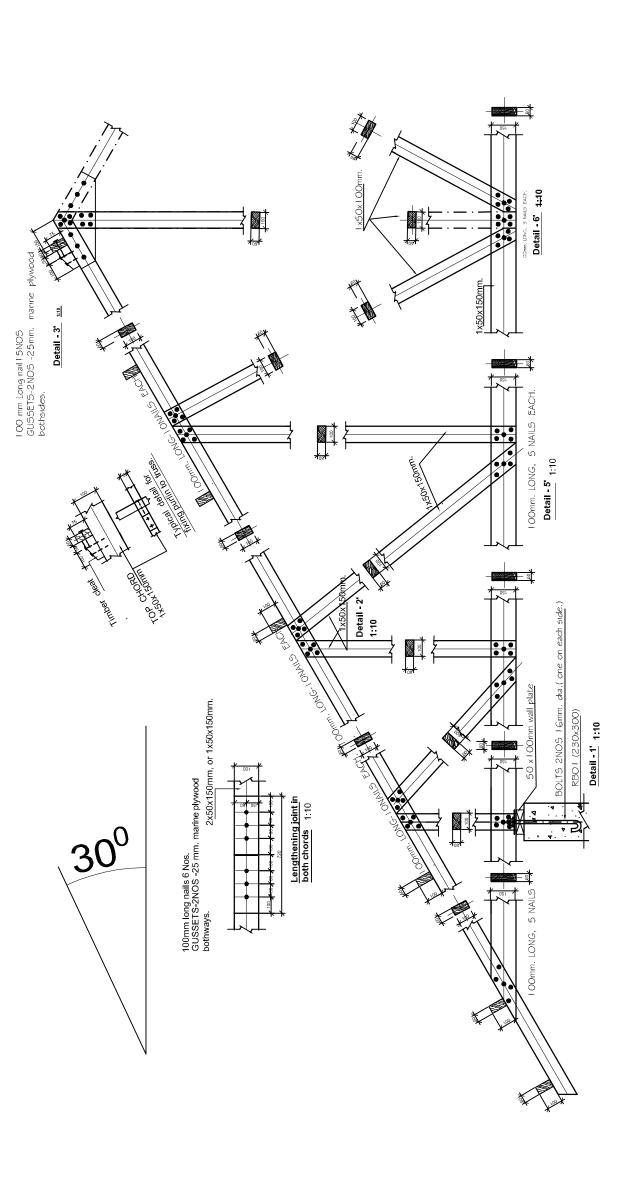

NOTE

All dimensions are in millimetres unless otherswise stated. In case of discrepancy, consult the Structural

All structural engineering drawings should be read in conjunction with relevant architectural drawings.
All Reinforced concrete shall be Grade 20 - Nominal volumetric proportion 1: 2: 4 cube strength not less than 20N/mm²

at 28 days. Steel for reinforced concrete shall comply with BS4449 whereby fy = 460N/mm². 4

5 9

Bars lap length should be at least 50 times the diameter of the bars lapped. Structural Engineer shall be furnished with copies of the manufacturers certificates of tests for the steel reinforcement to be used. Cement for works shall comply with BS12 and shall be "Ordinary Portland Cement".

7 8

use. Minimum Compressive Strength for Blocks shall be 3.5N/mm². 10

PROJECT:

PROVISION OF PHYSICAL FACILITIES IN PRIMARY SCHOOLS

MINISTRY OF EDUCATION, SCIENCE AND TECHNOLOGY

IN COLLABORATION WITH

PRESIDENT'S OFFICE REGIONAL ADMINISTRATION AND LOCAL GOVERNMENT.

Designed by Eng JM.S Checked by: Eng. N.T.B Approved by:

DRAWING TITLE:

TYPICAL TRUSS CONNECTIONS DETAIL

PROPOSED TWO - CLASSROOMS WITH OFFICE BLOCK

ROOF TRUSS CONNECTION DETAILS (REVISED - 1)

DRAWING USE:	For Building permit	For Construction

Drawn by:	2	STR.CR
S.M.S	Scale:	Sheet: 06/07

awn by:	J.M.S
ite: 2022	Scale:
awing No:STR.CR	Sheet: 06/07

g Sche	ALS - PROF	NO.OF BARS	4	4	4	4	210	8	98	8	72											
Bar Bending Sche	PROVISION OF PHYSICAL FACILITIES FOR PRIMARY SCHOOLS - PROP	LENGTH OF EACH BAR (mm)	12000	10300	10300	12000	096	9350	096	7850	800											
	AL FACILITIES FOF	BAR TYPE AND SIZE (mm)	Y12	Y12	Y12	Y12	γ8	Y12	γ8	Y12	γ8											
	OF PHYSIC.	MARK No.	10	05	03	04	05	10	02	10	02											
	PROVISION	NUMBER OF MEMBER	a	23	2	Ø	2	2	2	2	Ø											
9	Page 2/2	MEMBER TYPE	ROOF BEAM 1	ROOF BEAM 1	ROOF BEAM 1	ROOF BEAM 1	ROOF BEAM 1	ROOF BEAM 2	ROOF BEAM 2	ROOF BEAM 3	ROOF BEAM 3											
		•																•		•		
		NOTES																				
	OFFICE BLOCK	SKETCH OF BAR DIMENSIONS IN (mm)		10050		10251	20 20 180 180	11750	10050	10050	10921	105 N	10921	180	1092	20 20 180						
	PROVISION OF PHYSICAL FACILITIES FOR PRIMARY SCHOOLS - PROPOSED TWO CLASSROOMS WITH OFFICE BLOCK (GROUND FLOOR BEAMS)	TOTAL LENGTH (m)	48 105S	41.2	2.14 103SI	84	201.6	24 1052	50.6	20.6	24 -	100.8	74.8	82.56	74.8	82.56						
Schedule	S - PROPOSED T FLOOR BEAMS)	NO.OF BARS	4	4	4	4	210	8	a	8	α	105	ω	98	80	98						
Bar Bending Schedule	R PRIMARY SCHOOL (GROUND	LENGTH OF EACH BAR (mm)	12000	10300	10300	12000	096	12000	10300	10300	12000	096	9350	096	9350	096						
_	AL FACILITIES FOR	BAR TYPE AND SIZE (mm)	Y12	Y12	Y12	Y12	٧,8	Y12	Y12	Y12	Y12	γ8	Y12	γ.	Y12	У8						
	OF PHYSIC	MARK No.	10	02	03	04	90	01	02	60	04	05	01	02	01	02	 					
	PROVISION	NUMBER OF MEMBER	ď	Ø	a	2	2	-	-	-	-	-	8	2	8	2						
	Page 1/2	MEMBER TYPE	GROUND BEAM 1	GROUND BEAM 1	GROUND BEAM 1	GROUND BEAM1	GROUND BEAM 1	GROUND BEAM 2	GROUND BEAM 2	GROUND BEAM 2	GROUND BEAM 2	GROUND BEAM 2	GROUND BEAM 3	GROUND BEAM3	GROUND BEAM 4	GROUND BEAM4						

		NOTES																	
	THOFFICE BLOCK	SKETCH OF BAR DIMENSIONS IN (mm)	1050	10050	10050	11750	100 08 1 1 08 1 1 1 1 1 1 1 1 1 1 1 1 1	10321	105×1	10521	100 100								
0	FOR PRIMARY SCHOOLS - PROPOSED TWO CLASSROOMS WITH OFFICE (ROOF RING BEAMS)	TOTAL LENGTH (m)	48	41.2	41.2	48	201.6	74.8	82.56	62.8	57.6								
Schedul	LS - PROPOSEI F RING BEAMS)	NO.OF BARS	4	4	4	4	210	80	98	80	72								
Bar Bending Schedule	RIMARY SCHOC (ROOI	LENGTH OF EACH BAR (mm)	12000	10300	10300	12000	960	9350	096	7850	800								
	ON OF PHYSICAL FACILITIES FOR	BAR TYPE AND SIZE (mm)	Y12	Y12	Y12	Y12	Y8	Y12	٧8	Y12	Y8								
	N OF PHYSK	MARK No.	10	02	03	04	90	10	02	10	02								
	I	~ ~																	

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- All dimensions are in millimetres unless otherswise stated. In case of discrepancy, consult the Structural Engineer.

 All structural engineering drawings should be read in conjunction with relevant architectural drawings.

 All Reinforced concrete shall be Grade 20 Nominal volumetric proportion 1: 2: 4 cube strength not less than 20N/mm² at 28 days.

 Steel for reinforced concrete shall comply with BS449 whereby fy = 460N/mm².

 Steel for reinforced concrete shall comply with BS449 whereby fy = 460N/mm².

 Steel for reinforced concrete shall comply with copies of the manufacturers certificates of tests for the steel reinforcement to be used.

 Cement for works shall comply with BS12 and shall be "Ordinary Portland Cement".

 Clear cover for reinforcement shall be as follows: 7 m
 - 4
- 5. 9
- 7
- ω.

7

- œ 6
 - 10

PROJECT:

PROVISION OF PHYSICAL FACILITIES IN PRIMARY SCHOOLS

MINISTRY OF EDUCATION, SCIENCE AND TECHNOLOGY

IN COLLABORATION WITH

PRESIDENT'S OFFICE REGIONAL ADMINISTRATION AND LOCAL GOVERNMENT.

Designed by: Eng. J.M.S Checked by: Eng. N.T.B Approved by:

DRAWING TITLE:

PROPOSED TWO - CLASSROOMS WITH OFFICE BLOCK

GROUND FLOOR BEAMS AND ROOF RING BEAMS BAR BENDING SCHEDULES (**REVISED - 1**)

DRAWING USE:	For Building permit	For Construction:

<u>}</u>	J.M.S	Scale:
	Drawn by:	Date: 2022

Clawii Dy.	0
Date: 2022	Scale:
Drawing No.STR.CR	Sheet: 07/07

Page 1/2 PROVISION OF PHYSICAL FACILITIES FOR PRIMARY SCHOOLS - PROPOSED TWO CLASSROOMS WITH OFFICE BLOCK (GROUND FLOOR BEAMS) MEMBER TYPE OF MEMBER No. MARK OF MEMBER No. MEMBER NO


				(GROUN	ID FLOOR BEAM	MS)		
MEMBER TYPE	NUMBER OF MEMBER	MARK No.	BAR TYPE AND SIZE (mm)	LENGTH OF EACH BAR (mm)	NO.OF BARS	TOTAL LENGTH (m)	SKETCH OF BAR DIMENSIONS IN (mm)	NOTES
GROUND BEAM 1	2	01	Y12	12000	4	48	11750	
GROUND BEAM 1	2	02	Y12	10300	4	41.2	10050	
GROUND BEAM 1	2	03	Y12	10300	4	41.2	10050	
GROUND BEAM 1	2	04	Y12	12000	4	48	11750	
GROUND BEAM 1	2	05	Y8	960	210	201.6	50 50 002 180	
GROUND BEAM 2	1	01	Y12	12000	2	24	11750	
GROUND BEAM 2	1	02	Y12	10300	2	20.6	10050	
GROUND BEAM 2	1	03	Y12	10300	2	20.6	10050	
GROUND BEAM 2	1	04	Y12	12000	2	24	11750	
GROUND BEAM 2	1	05	Y8	960	105	100.8	50 092 180	
GROUND BEAM 3	2	01	Y12	9350	8	74.8	8850	
GROUND BEAM 3	2	02	Y8	960	86	82.56	50 50 0.90 180	
GROUND BEAM 4	2	01	Y12	9350	8	74.8	8850	
GROUND BEAM 4	2	02	Y8	960	86	82.56	50 50 99 180	


Bar Bending Schedule


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PROVISION OF PHYSICAL FACILITIES FOR PRIMARY SCHOOLS - PROPOSED TWO CLASSROOMS WITH OFFICE BLOCK
(ROOF RING BEAMS)

	FROVISION	I OF FRISI	JAL FACILITIES FO		F RING BEAMS		S WITH OFFICE BLOCK	
MEMBER TYPE	NUMBER OF MEMBER	MARK No.	BAR TYPE AND SIZE (mm)	LENGTH OF EACH BAR (mm)	NO.OF BARS	TOTAL LENGTH (m)	SKETCH OF BAR DIMENSIONS IN (mm)	NOTES
ROOF BEAM 1	2	01	Y12	12000	4	48	11750	
ROOF BEAM 1	2	02	Y12	10300	4	41.2	10050	
ROOF BEAM 1	2	03	Y12	10300	4	41.2	10050	
ROOF BEAM 1	2	04	Y12	12000	4	48	11750	
ROOF BEAM 1	2	05	Y8	960	210	201.6	50 50 50 20 1180	
ROOF BEAM 2	2	01	Y12	9350	8	74.8	8850	
ROOF BEAM 2	2	02	Y8	960	86	82.56	50 50 20 180	
ROOF BEAM 3	2	01	Y12	7850	8	62.8	7350	
ROOF BEAM 3	2	02	Y8	800	72	57.6	50 000 100	



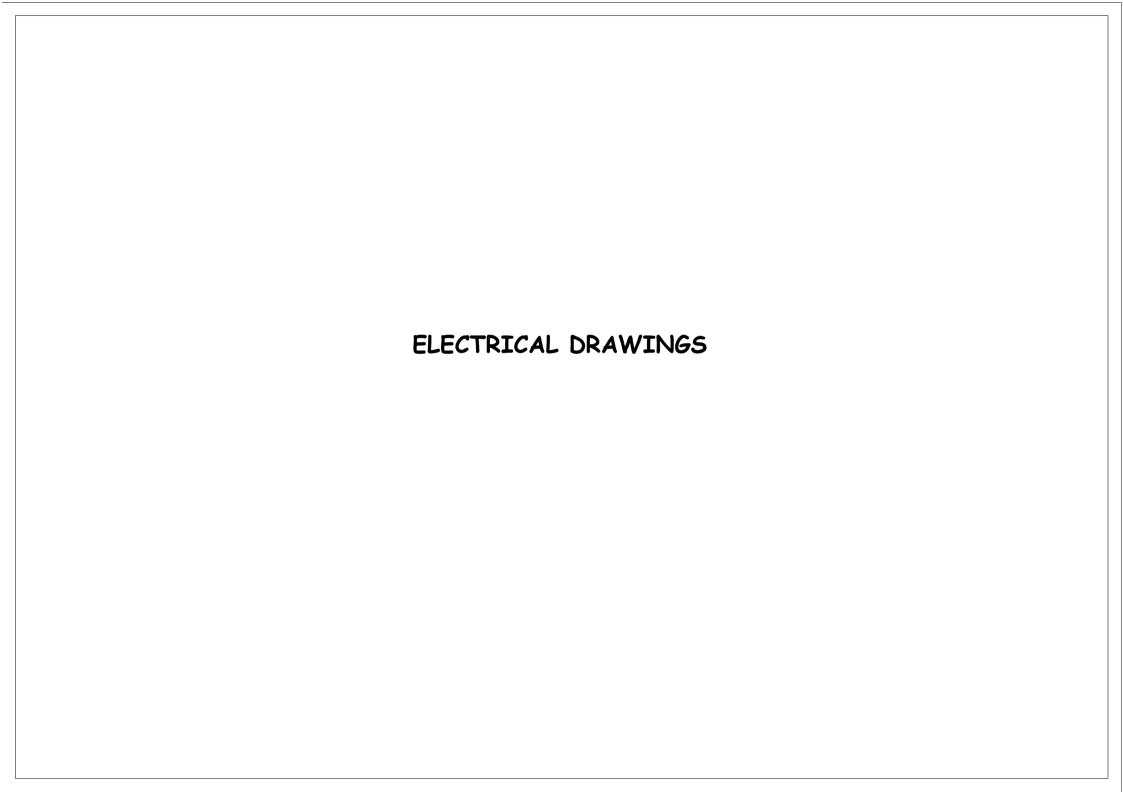

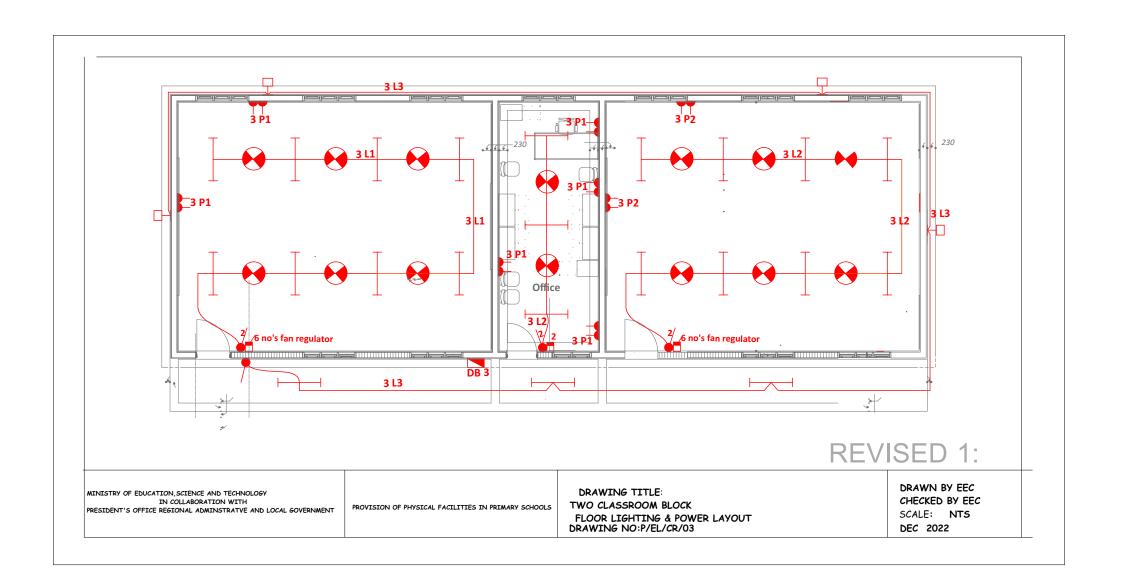

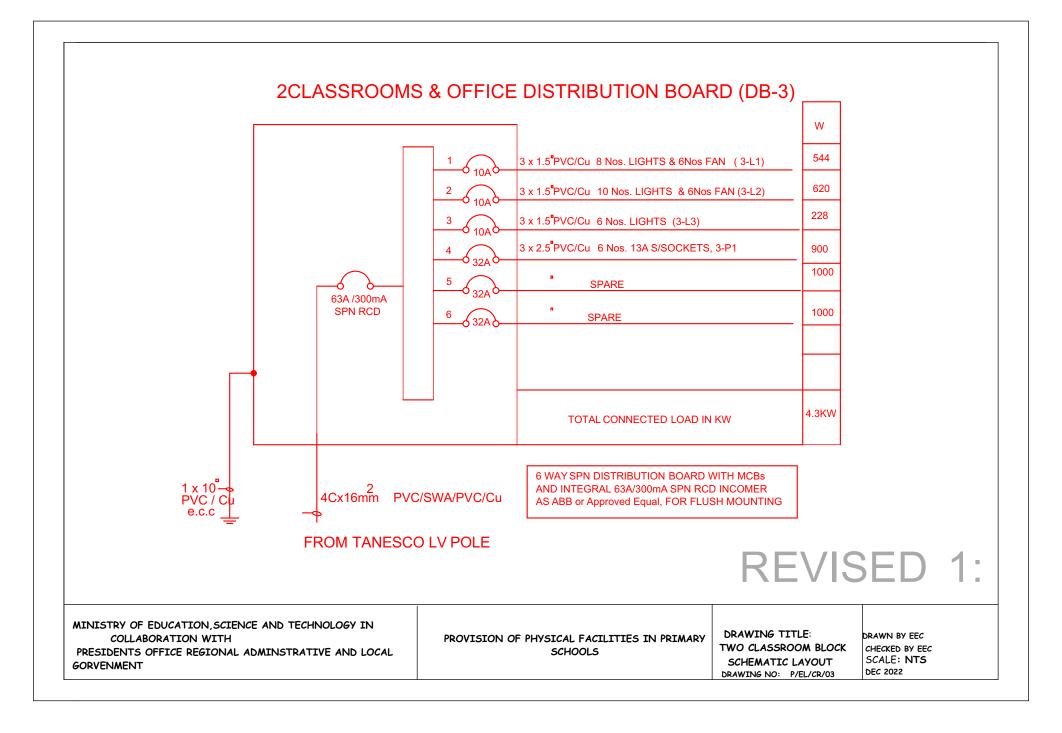KEY TO SYMBOLS

SYMBOL	DESCRIPTION	MOUNTING HEIGHT
	Distribution Board with integral RCD	2000 mm AFFL
Н	Bulkhead light Fitting	Wall Mounted
 	4FT Single Electronic Start Fluorecent Light	On Ceilling
	Ceilling Fan	On Ceilling
	Fan Regulator	1500 mm AFFL
\	1 gang 1way Switch	1500 mm AFFL
4	1 gang 2way Switch	1500 mm AFFL
42	2 gang 2way Switch	1500 mm AFFL
3	3 gang 1way Switch	
2	2 gang 1way Switch	1500 mm AFFL
\ <u>\</u>	4 gang 1way Switch	1500 mm AFFL
	Twin Switch Socket	450 mm AFFL
©	Ceilling light complete with energy saver 11w	on level

MINISTRY OF EDUCATION, SCIENCE AND TECHNOLOGY IN
COLLABORATION WITH
PRESIDENTS OFFICE REGIONAL ADMINSTRATIVE AND LOCAL
GORVENMENT

PROVISION OF PHYSICAL FACILITIES IN PRIMARY SCHOOLS

DRAWING TITLE:
THREE CLASSROOM BLOCK
LEGEND
DRAWING NO: P/EL/CR/03

DRAWN BY EEC
CHECKED BY EEC
SCALE: NTS
DEC 2022