THE UNITED REPUBLIC OF TANZANIA



PRESIDENT'S OFFICE REGIONAL ADMINISTRATION AND LOCAL GOVERNMENT

PROPOSED STANDARD DRAWINGS FOR SCHOOL FACILITIES.


Schedule of Materials, Labour & Drawings for Pre Primary Two Classroom Block – Gable

PROJECT AREA

TANZANIA MAINLAND

Ministry of Education, Science and Technology,

Government City - Mtumba, AFYA -Street, P. O. Box 10, **40479 DODOMA.** President's Office, Regional Administration, & Local Government Government City - Mtumba TAMISEMI Street, P. O. Box 1923, 41185 DODOMA.

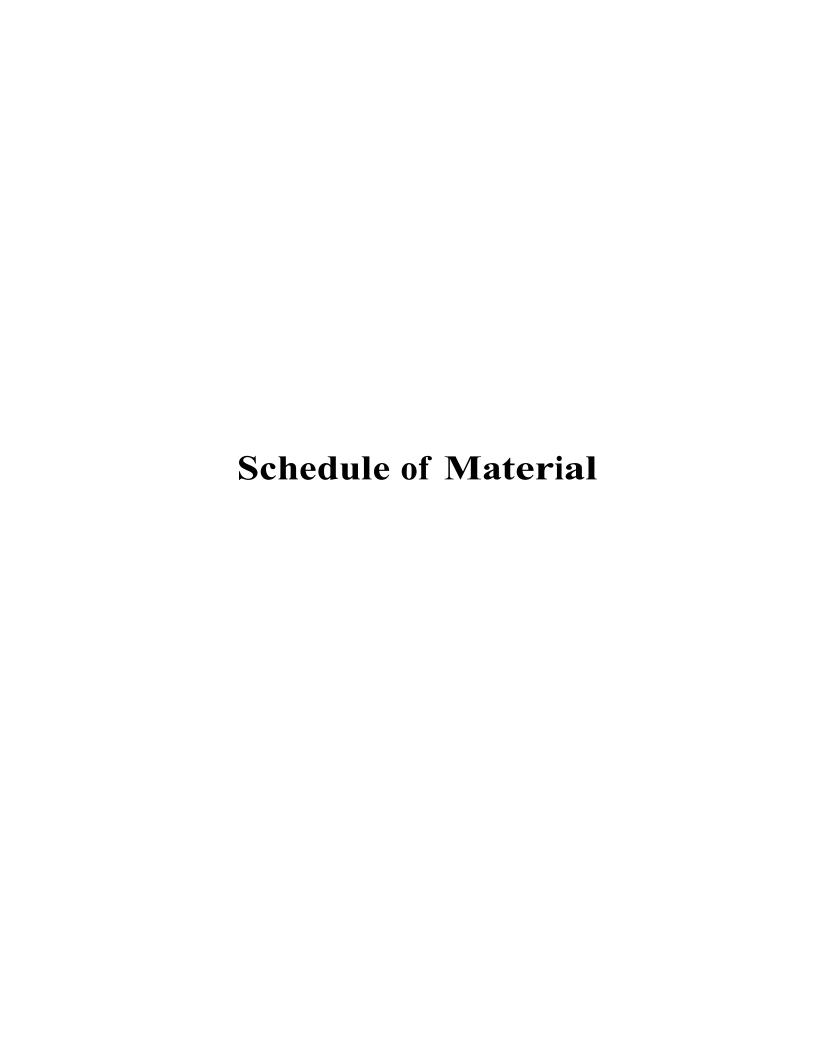

ITEM	DESCRIPTION	QTY	UNIT	PRICE-TZS	AMOUNT
	MATERIALS				
Α	SUB-STRUCTURE -PROVISIONAL				
1	Strip Foundation - Grade 15 Plain				
•	Aggregate (3/4")	0	M^3		
	Sand		M ³		
	Cement-50kgs (42.5)		Bags		
	comonic congo (12.0)		Dago		
2	Foundation Walls				
	6" Cement & Sand block - Minimum Strength 3. 5 MPa	1,050	No		
	Sand		M^3		
	Cement -50kgs (42.5)	18	Bags		
3	Moram, Hardcore & Site sterilization				
	Moram (4.5m³ lorry)	8	Trips		
	Hardcore 200mm thick - (4.5m ³ lorry)		Trips		
	Sand	6	M ³		
	Aldrin solution or other and equal approved (1000mls)	2	Bottle		
4	Oversite Concrete 100mm thick - 15 grade ,Ground Beam and base column - 20 grade				
	DPM	160	M^2		
	Cement -50kgs (42.5)	115	Bags		
	Aggregates (1/2")	19	M^3		
	Sand	10	M^3		
	Reinforcement - 12mm diameter high tensile 460N/mm2		PC'S		
	Reinforcement - 8mm diameter high tensile 460N/mm2	34	PC'S		
	Binding Wire - 25kg	8	Kgs		
	A252 Mesh 200 x 200x 6.16kg/m2	4	PC'S		
	Timber 1" X 10 " (5.2m long)	15	PC'S		
	Timber 2" X 2"	10	PC'S		
	Nails-4"	10	Kgs		
	Nails-3"		Kgs		
	Supporting props SUB-TOTAL SUBSTRUCTURE	6	PC'S		
				-	
В.	SUPERSTRUCTURE				
1	Walls Ring beam & Columns	2,128	No		
	6" Cement & Sand block - Minimum Strength 3. 5 MPa - 230mm				
	6" Cement & Sand block - Minimum Strength 3. 5 MPa - 150mm	235			
	DPC 25m		Roll		
	Sand		M ³		
	Cement-50kgs (42.5)		Bags		
	Aggregates (1/2") Painforcement 12mm diameter high topoile 460N/mm2		M ³		
	Reinforcement - 12mm diameter high tensile 460N/mm2		PC'S		
	Reinforcement - 8mm diameter high tensile 460N/mm2	25	PC'S		

ITEM	DESCRIPTION	QTY	UNIT	PRICE-TZS	AMOUNT
	Binding Wire - 25kg	8	Kg		
	Timber 1" X 10" to Sides (5.2m long)	18	PC'S		
	Timber 1" X 5" (Plates)	4	PC'S		
	Timber 2" X 2"	10	PC'S		
	Supporting Props	10	PC'S		
	SUB-TOTAL SUPER STRUCTURE				
C.	ROOF STRUCTURE & COVERING				
1	Roof Structure - Provisional				
	Timber 2 " X 3" Purlins	50	PC'S		
	Timber 2" X 4" King Post, wall plate and struts	78	PC'S		
	Timber 2" X 6" Rafter and Tie beam	60	PC'S		
	Fascia board 1" X 10" -ref. Semi Hardwood (5.2m long)		PC'S		
	Nails -5"		Kgs		
	Nails -4"				
			Kgs		
	Nails -3"		Kgs		
	16mm diameter bolt NOTE: The above softwood timber structure should be pressure impregnated treated	20	Pc's		
2	Roof Covering				
	28G IT5 resin coated sheet size 3000x900mm	102	PCS		
	Hips/Ridge and valley - 28 G IT resin coated	9	PC'S		
	Roofing Nails	23	Packet		
3	Gutter's				
	Upvc 100mm half round (6m long)-5"	7	PC'S		
	Upvc 75mm diameter down pipe; Class B	2	PC'S		
	PVC outlet	2	PC'S		
	Gutter support bracket	16	PC'S		
	PVC bend 90'	2	PC'S		
	PVC bend 45'	4	PC'S		
	Gutter Clamp 3"		PC'S		
	Connector/reducer		PC'S		
	Connector outer		PC'S		
	Corner Inner Water storage tank; 5000 litres capacity with dust and insect proof lid; 20mm 3Nr tank connectors; 25mm 1Nr wash - out tank connector; 20mm high pressure ball float operated stop valve; all connections to IPS	2	PC'S		
	SUB-TOTAL ROOF STRUCTURE & COVERING				
D.	CEILING				
	Gypsum board -9mm thick	56	PC'S		
	Plain Cornice (8ft)	40	PC'S		
	Screw 1.25" 500pcs/box	3	Box		
	Gypsum powder	10	Bags		
	Fiber tape (90m)	2	Roller		
	Treated softwood Timber 2" X 2"	100	PC'S		
	Nails 4"		Kgs		
	Nails 3"	25	Kgs		
	SUB-TOTAL FOR CEILING				

TEM	DESCRIPTION	QTY	UNIT	PRICE-TZS	AMOUNT
	<u>DOOR</u>				
1	40mm thick hardwood Matchboarded door shutter				
	820 x 2100mm high	2	PC'S		
2	45 X 145mm Frames (hardwood), Varnish				
	900 x 2500 mm high frame	2	PC'S		
	5mm thick clear glass to Vents	1	m2		
	16mm diametere burglar bars -1100mm long	6	Pcs		
	Brush 3"		Pcs		
	Sand paper (msasa) No.80		LM		
	Clear Varnish - 4Litres		TIN		
	Thinner for Varnish		Litres		
3	Ironmongeries - ref Union		Litioo		
	Mortice lock Three lever	2	No		
	Brass hinges - 100mm		Pairs		
	SUB-TOTAL FOR DOORS		i ali s	_	
F.	WINDOWS				
<u>' ' '</u>	Aluminium sliding Window comprising 100mm x 1.2mm thick				
	standard aluminium profile ex-china/Turkey infill with 5mm				
	thick glass complete with mosquito proofing panel, including				
	all accessories, ironmongeries, cutting and pinning lugs				
	1500 X 2000mm high	10	PC'S		
	SUB-TOTAL FOR WINDOWS				
G.	<u>FINISHING</u>				
1	Floor finishing				
	Bedding/Backing; cement sand and Chipping (1:2:2); to steel				
	<u>finishing</u>				
	40mm Thick granolithic floor screed steel trowlelling to smooth				
	finishing				
	Sand	9	M^3		
	Cement-50kgs (42.5)	58	Bags		
	Chipping "1/4"	13	M^3		
	2mm thick plastic Strips	205	М		
2	Wall Finishing -15mm thick (1:4)				
	Sand	12	M^3		
	Cement-50kgs	78	Bags		
	Sand paper (msasa) No.120	10			
	White cement - 40kg		Bags		
	Gypsum powder		Bags		
	Эурсин ретис	• • •	Bago	-	
	SUB-TOTAL FOR FINISHING				
Н	SUB-TOTAL FOR FINISHING				
Н.	BALUSTERS & HANDRAIL				
Н.	BALUSTERS & HANDRAIL Supply and fix steel balustrade overall height 900mm high,				
Н.	BALUSTERS & HANDRAIL Supply and fix steel balustrade overall height 900mm high, comprising 50mm diameter hollow section mild steel pipe top and				
н.	BALUSTERS & HANDRAIL Supply and fix steel balustrade overall height 900mm high, comprising 50mm diameter hollow section mild steel pipe top and bottom rail, 38mm diameter intermediate rails, 50mm diameter				
Н.	BALUSTERS & HANDRAIL Supply and fix steel balustrade overall height 900mm high, comprising 50mm diameter hollow section mild steel pipe top and bottom rail, 38mm diameter intermediate rails, 50mm diameter vertical rails 900mm high spaced at interval of 450mm centres				
Н.	BALUSTERS & HANDRAIL Supply and fix steel balustrade overall height 900mm high, comprising 50mm diameter hollow section mild steel pipe top and bottom rail, 38mm diameter intermediate rails, 50mm diameter vertical rails 900mm high spaced at interval of 450mm centres to centres including all bolts, plates and associated accessories				
Н.	BALUSTERS & HANDRAIL Supply and fix steel balustrade overall height 900mm high, comprising 50mm diameter hollow section mild steel pipe top and bottom rail, 38mm diameter intermediate rails, 50mm diameter vertical rails 900mm high spaced at interval of 450mm centres	18			

TEM	DESCRIPTION	QTY	UNIT	PRICE-TZS	AMOUNT
J.	PAINTING & DECORATION				
	Emulsion Paint - 20 LTRS	9	buckets		
	Weather guard Paint - 20 LTRS	3	buckets		
	Washable paint -20 LTRS	3	buckets		
	Primer paint -20 LTRS	2	buckets		
	Solvent - 5LTRS	2	TIN		
	Brush 3"	4	Pcs		
	Roller	4	Pcs		
	Blackboard paint	4	Litres		
	Gloss paint-4LTR	3	TIN		
	Bitumen paint - 4Litres	4	TIN		
	SUB-TOTAL FOR PAINTING&DECORATION				
K.	ELECTRICAL INSTALLATION				
	Single fluorescent fitting Complete,LED philips or other equal approved	18	No		
	Double switch socket ABB or other equal approved	2	No		
	Main switch 6way,1PH with integral RCD 100A/300mmA ABB other equal approved NB: Cables for 1.5sqmm 2.5sqmm and 4sqmm should be EURO or	1	No		
	other equal approved				
	Single core wire 1.5sqmm - Red	2	Roll		
	Single core wire 1.5sqmm - Black	2	Roll		
	Single core wire 1.5sqmm -green Single core wire 2.5sqmm - red	2 50	Roll M		
	Single core wire 2.5sqmm	50	M		
	Single core wire 2.5sqmm green	50	М		
	Ceiling fan National or other equal approved	12	PC's		
	3gang 1 way switch ABB or other equal approved		No		
	1gang 1 way switch ABB or other equal approved		No		
	2gang 1 way switch ABB or other equal approved		No		
	Earth rod approved copper 16mm not less than 1200mm	1	INO		
			No		
	Earth wire 4sqmm	20	M		
	Metal box twin	2	No		
	Metal box single	7	No		
	Junction box		No		
	Conduit pipe		PC's		
	Elbow		PC's		
	Conduit coupling		PC's		
	Round cover		PC's		
	Round box		PC's		
	Fine screw		PACKET		
	plastic clips 22mm		BOX		
	Bulk head light fitting	4	PCS		

ITEM	DESCRIPTION				AMOUNT -TZS
	SUMMARY				
	ONLY OF ACCORDING DISCOUNTED PRIMARY				
	2No CLASSROOM BLOCK -PRE- PRIMARY				
Α.	SUB-STRUCTURE -PROVISIONAL				
B.	SUPERSTRUCTURE				
C.	ROOF STRUCTURE & COVERING				
D.	CEILING				
D.	CLILING				
E.	DOOR				
F.	WINDOWS				
	FINIOLINIO				
G.	FINISHING				
Н.	BALUSTERS & HANDRAILS				
J.	PAINTING & DECORATION				
K.	ELECTRICAL INSTALLATION				
	TOTAL BUILDING MATERIALS CARRIED TO GENERAL SUMMARY				
	TO THE BOLESING INVIENDED STATE OF THE BOLINIAN IN				
	ADD:				
	LABOUR COST CARRIED TO GENERAL SUMMARY : (Improve and F	ill the	respective	Labour form)	
	Note:				
	i. Refer specification and number of Furniture(s) for Pre primary s			•	
	ii. Refer General Summary for: Preliminary, Transportation and Su	upervi	sion Cos	ts .	
	iii. Preliminary cover the following item:Setting out working tools, Equipments, Temporary toilets, water	for th	e works	Scaffolding	
	- Power for the works, Security, store, Materials test, levelling, he				ish
	iv. Supervision cost depend on guideline of the specific project	cianig	o ana rei	noval of Tubb	
	v. Installation of Ceiling Fan is an option, depend on whether cond	dition	of specifi	c area .	

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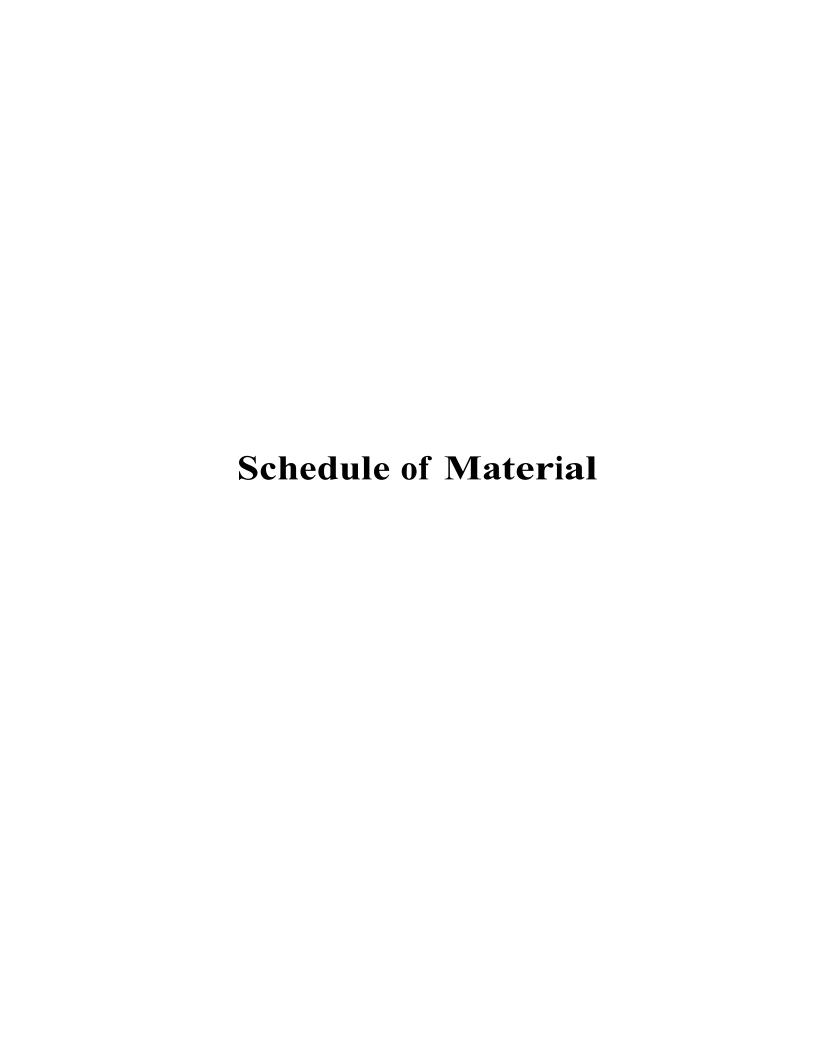
Schedule of Materials, Labour & Drawings for Three stances Toilet block for Pre Primary school

PROJECT AREA

TANZANIA MAINLAND

Ministry of Education, Science and Technology,

Government City - Mtumba, AFYA -Street, P. O. Box 10, **40479 DODOMA.** President's Office, Regional Administration, & Local Government Government City - Mtumba TAMISEMI Street, P. O. Box 1923, 41185 DODOMA.



ITEM	DESCRIPTION	QTY	UNIT	PRICE-TZS	AMOUNT
	<u>MATERIALS</u>				
Α	SUB-STRUCTURE -PROVISIONAL				
1	Strip Foundation - Grade 15 Plain				
	Aggregate (3/4")		M^3		
	Sand		M_3		
	Cement-50kgs (42.5)	14	Bags		
2	Foundation Walls				
	6" Cement & Sand block - Minimum Strength 3. 5 MPε				
	Sand	2	M^3		
	Cement -50kgs (42.5)	5	Bags		
3	Moram, Hardcore & Site sterilization				
	Moram (4.5m³ lorry)	1	Trips		
	Hardcore (4.5m³ lorry)	1	Trips		
	Sand	2	M^3		
	Aldrin solution or equal 1000mls	1	Bottle		
4	Ground Beam - 20 grade, columns and Ramp DPM	15	M^2		
	Cement -50kgs (42.5)		Bags M ³		
	Aggregates (1/2") Sand				
	Reinforcement - 12mm diameter high tensile		M ³ PC'S		
	Reinforcement - 8mm diameter		PC'S		
	Binding Wire		Kg		
	A252 Mesh 200 x200x6.16kg/m2		PC'S		
	Timber 1" X 10 " (3.6m long)		PC'S		
	Timber 2" X 2"		PC'S		
	Nails-4"		Kgs		
	Nails-3"		Kgs		
	Supporting props		PC'S		
	SUB-TOTAL SUBSTRUCTURE				

EM	DESCRIPTION	QTY	UNIT	PRICE-TZS	AMOUNT
В.	SUPERSTRUCTURE				
1	Walls & Ring beam & Columns				
	6" Cement & Sand block - Minimum Strength 3.5 N	558			
	Cement & Sand Perforated blocks	0	No		
	DPC 25m long x 1m wide)	5	M		
	Sand	4	M^3		
	Cement-50kgs (42.5)	15	Bags		
	Aggregates (1/2")	1	M^3		
	Reinforcement - 12mm diameter high tensile	6	PC'S		
	Reinforcement - 8mm diameter	4	PC'S		
	Binding Wire	2	kg		
	A252 Mesh 200 x200x6.16kg	0	PC'S		
	Timber 1" X 10" to Sides (3.6m long)	3	PC'S		
	Timber 1" X 6" (Plates)	1	PC'S		
	Timber 2" X 2"		PC'S		
	Supporting Props		PC'S		
	a state a state				
	SUB-TOTAL SUPER STRUCTURE				
С.	ROOF STRUCTURE & COVERING				
1	Roof Structure - Provisional (3.6m long)				
	Timber 2 " X 3" Purlins		PC'S		
	Timber 2" X 4" Wall plate,Rafter Fascia board 1" X 8"		PC'S PC'S		
	Nails -5"				
	Nails -4"		Kgs		
			Kgs		
	Nails -3" NOTE: The above softwood timber structure should	2	Kgs		
	be pressure impregnated treated				
	in the state of th				
2	Roof Covering				
	28G IT5 resincoated sheet 3m long	5	Pcs		
	Roofing Nails		Packet		
	_		1 acker	C /F	
	TO COLLECTION			C/F	

ITEM	DESCRIPTION DESCRIPTION	QTY	UNIT	PRICE-TZS	AMOUNT
11 = / V	ROOF STRUCTURE & COVERING CONT	QII	OINII	FRICE-123	AMOUNT
	ROOF STRUCTURE & COVERING CONT			D/E	
3	Gutter's			B/F	
	Upvc 100mm half round (6m long)-5"	1	PC'S		
	Upvc 75mm diameter down pipe; Class B		PC'S		
	PVC outlet		PC'S		
	PVC bend 45'		PC'S		
	Gutter support bracket		PC'S		
	Gutter Clamp 3"		PC'S		
	Connector		PC'S		
	Connector outer		PC'S		
	Corner Inner		PC'S		
	SUB-TOTAL ROOF STRUCTURE & COVERING				
D.	DOOR				
1	40mm thick hardwood (mninga) or equal and				
	aproved paneled door shutter				
	920 x 2100mm high	1	PC'S		
	720 x 2100mm high	2	PC'S		
2	Frames (hardwood), Varnish, Glass & Burglar bar				
	1000 x 2500 mm high frame	1	PC'S		
	800 x 2500 mm high frame	2	PC'S		
	Brush 3"	1	Pcs		
	Sand paper (msasa) No.80	1	LM		
	Clear Varnish - 4Litres	1	TIN		
	Thinner for Varnish -4Litres	1	Litres		
	Door grill with 38mm x 4mm flat bars, 25mm x 25mm square pipespainted with red oxide				
	1000 x 1500mm high	1	No		
	1000 x 750mm high	3			
3	IronMongeries - ref Union				
	Barrel bolt with pad lock	3	No		
	Flush bolt	3	No		
	Brass hinges - 100mm	5	Pairs		
	SUB-TOTAL FOR DOORS				

ITEM	DESCRIPTION	QTY	UNIT	PRICE-TZS	AMOUNT
E.	FINISHING				
1	Floor finishing				
•	Bedding/Backing; cement sand (1:2); to steel				
	finishing				
	Sand	1	M^3		
	Cement-50kgs (42.5)	2	Bags		
	300 x 300 x 8mm Non slippery Porcelain floor tiles	F	D		
	(1.35 sqm per Box)	5	Box		
2	Wall Finishing				
	Sand	2	M^3		
	Cement-50kgs		Bags		
	250 X 400 x 8mm Wall tiles (1.5 Sqm/Box)	18	Вох		
	Wall Puty		Bags		
	SUB-TOTAL FOR FINISHING		9-		
F.	PAINTING & DECORATION				
1.	Emulsion Paint - 20 LTRS	2	buckets		
	Weather guard Paint - 10 LTRS		buckets		
	Washable paint -10 LTRS		buckets		
	Primer paint -5 LTRS	1	buckets		
	Solvent - 5LTRS	1	TIN		
	Brush 3"	2	Pcs		
	Roller	1	Pcs		
	Gloss paint-4LTR	1	TIN		
	Bitumen paint - 4Litres	1	TIN		
	SUB-TOTAL FOR PAINTING&DECORATION				
G.	PLUMBING & SANITARY INSTALLATION-PROVISIONAL				
	Semi pedestal Hand washing basin complete	No	2		
	WC Asian type complete with p-trap 9 liters single				
	flush cistern Shataf stainless steel 304, 1000mm long braided	No	2		
	hose.	No	2		
	Angle Valve chrome plated brass	No	9		
	HWB PVC-U trap 1.1/4'' Falcon	No	2		
	Looking mirror (600mm by 800mm by 6mm)	No	2		
	PVC-U Floor drainer/Trap 110mm	No	1		
	Strainer albeetony/venus	No	1		
	Ceramic toilet paper holder	No	2		
	Toilet brush holder	No	2		
	Complete set of walfare for person with disability,				
	Western WC, stainless steel 304 grab bar, stainless				
	steel 304 folding hand rail, HWB, Pillar tap, Floor				
	drainer and bib cork	No	1		

M DESCRIPTION OF WORKS	UNIT	QTY	PRICE	AMOUNT
PIPES WORK IN BUILDING				
A: SUPPLY PIPE PN 16				
PPR/IPS pipes class B argentina 3/4"	Pcs	2		
PPR/IPS socket (20Ø) 3/4"	No	3		
PPR/IPS elbow (20Ø) 3/4"	No	15		
PPR/IPS tee (20Ø) 3/4"	No	9		
PPR/IPS niple (20Ø) 3/4"	No	10		
PPR/IPS reducing bush (20Ø) 3/4" to 1/2"(15Ø)	No	9		
PPR/IPS pipes class B argentina 1"(32Ø)	Pcs	2		
PPR/IPS socket 1"(32Ø)	No	6		
PPR/IPS elbow 1"(32Ø)	No	4		
PPR/IPS tee 1"(32Ø)	No	4		
PPR/IPS niple 1"(32Ø)	No	10		
PPR/IPS reducing bush (32Ø) 1" to 3/4"(20Ø)	No	6		
PPR/IPS pipes class B argentina 11/2"(50Ø)	Pcs	2		
PPR/IPS socket 11/2"(50Ø)	No	6		
PPR/IPS elbow 11/2"(50Ø)	No	4		
PPR/IPS tee 11/2"(50Ø)	No	4		
PPR/IPS niple 11/2"(50Ø)	No	4		
PPR/IPS reducing bush (50Ø) 11/2" to 1"(32Ø)	No	9		
B: SOIL DRAINAGE PVC-U PN6 PIPES AND FITINGS -				
PVC-U pipe class B 1.1/4"	Pcs	2		
PVC-U elbow 1.1/4", 135deg	No	3		
PVC-U elbow 1.1/4", 90 deg	No	4		
PVC-U Ytee 1.1/4"	No	2		
PVC-U pipe class B 4"	Pcs	2		
PVC-U elbow 4"	No	6		
PVC-U Ytee 4"	No	2		
PVC-U WYES 4"	No	1		
PVC-U Tangit 1000g	No	2		
P-Trap ERA 4"	No	1		
PE 100 Gully trap 4",ERA	No	1		
, , , ,	-			

	DESCRIPTION		HAUT		A AAOUNT
ITEM		QTY	UNIT	PRICE-TZS	AMOUNT
	EXTERNAL WORK A: Drainage works				
	PVC-U pipe class B plascon 4" 6m	Pcs	6		
	ManHole cover 600mm x 600mm medium	No	4		
	Gully trap cover 300mm x 300mm medium	No	3		
	B: Water Supply Pipe HDPE, PE100	140	0		
	1.5" HDPE supply pipes Class C	m	12		
	HDPE bend 1.5"	No	2		
	HDPE Tee Polly to polly 1.5"	No	3		
	HDPE polly coupling 1.5"	No	4		
	1.25" HDPE supply pipes Class C	m	12		
	HDPE bend 1.25"	No	5		
	HDPE Male connector 1.25"	No	4		
	HDPE Tee Polly to polly 1.25"	No	4		
	HDPE polly coupling 1.25"	No	4		
	VALVES AND CONTROLS				
	Bib cork pex/martex 1/2" PN 16	No	2		
	Gate valve pex/martex 3/4" PN 16	No	3		
	Ball valve 11/4"	No	1		
	WATER STORAGE TANK				
	2,000litres water storage tank	No	1		
	1,000litres water storage tank	No	1		
	Tank connector 1"	No	2		
	Clamp 3"	PC'S	1	_	
	SUB-TOTAL FOR PLUMBING & SANITARY INSTALLATION-				
•	RISER FOR WATER TANK (4M HIGH)				
	6" Cement & Sand block - Minimum Strength 3.5 MPa	190	No		
	Cement-50kgs	8	Bags		
	Aggregates (1/2")	1	МЗ		
	Sand	3	МЗ		
	Reinforcement - 12mm diameter high tensile	4	Pcs		
	Binding Wire - 25kg	1	kg		
	Timber 1" X 10" to Sides (3.6m long)	6	Pcs		
	Nails-4"	1	kg		
	Nails-3"	1	kg		
	TOTAL; RISER FOR TANK				

ITEM	DESCRIPTION	QTY	UNIT	PRICE-TZS	AMOUNT
J.	MANHOLE, GULLY TRAP, SEPTIC TANK, SOAK PIT.				
	MANHOLE:				
	Construct standard manhole size 600 x 600mm average depth 850mm deep;	No	3		
	GULLY TRAP				
	Construct a standard gully trap 300×300mm deep	No	3		
	SEPTIC TANK:				
	Construct septic tank overall internal dimensions; size 3300 x 2400x 3000mm.	No	1		
	SOAK PIT (S.P)				
	Construct Soak pit overall size 3000mm diameter x 3500mm high	No	1		
	TOTAL; MANHOLE, GULLY TRAP, SEPTIC TANK, SOAK PIT.				

ELECTRICAL INSTALLATION			
PRE PRIMARY TOILET			
Single fluorescent fitting Complete,LED philips or	4	No	
NB: Cables for 1.5sqmm 2.5sqmm and 4sqmm should be EURO or other equal approved			
Single core wire 1.5sqmm - Red	30	М	
Single core wire 1.5sqmm - Black	30	M	
Single core wire 1.5sqmm -green	30	M	
Twin cable wire 2.5sqmm	30	M	
1gang 1 way switch ABB or other equal approved	3	No	
Ceiling light complete with energy saver 11w	3	No	
Metal box single	3	No	
Junction box	3	No	
Conduit pipe	3	PC's	
Elbow	3	PC's	
Conduit coupling	3	PC's	
Round cover	3	PC's	
Round box	1	PC's	
plastic clips 22mm	1	вох	
SUB-TOTAL FOR ELECTRICAL INSTALLATIONS			

SCHEDI	JLES OF MATERIALS PRE PRIMARY STAN	PRE PRIMARY STANCES							
ITEM	DESCRIPTION	QTY	UNIT	PRICE-TZS	AMOUNT				
L	Steel handrails to ramp								
	Supply and fix steel support handrails 750mm high								
	comprising 38mm diameter hollow section pipe								
	top, bottom and vertical rails spaced at 300mm								
	centres to centres as per Architectural drawings	8	m						
	SUB-TOTAL FOR HANDRAILS								

	GENERAL SUMMARY	AMOUNT TZS
	2no stances with One Disability stances toilets block -Wet area	
Α.	SUB-STRUCTURE -PROVISIONAL	
В.	SUPERSTRUCTURE	
C.	ROOF STRUCTURE & COVERING	
D	DOOR	
Е	FINISHING	
F	PAINTING & DECORATION	
G	PLUMBING & SANITARY INSTALLATION-PROVISIONAL	
Н	RISER FOR WATER TANK	
J	MANHOLE, GULLYTRAP, SEPTIC TANK AND SOAK PIT	
K	ELECTRICAL INSTALLATIONS	
L	HANDRAILS TO RAMP	
	TOTAL BUILDING MATERIALS CARRIED TO GENERAL SUMMARY	
	ADD:	
	LABOUR COST CARRIED TO GENERAL SUMMARY : (Improve and Fill the respective	ve Labour form)
	Note:	
	i Refer General Summary for: Preliminary, Transportation and Supervision Cos	ts
	ii. Preliminary cover the following item:	
	- Setting out working tools, Equipments, Temporary toilets, water for the works	<u> </u>
	- Power for the works, Security, store, Materials test, levelling, holdings and re	emoval of rubbis
	iii. Supervision cost depend on guideline of the specific project	

THE UNITED REPUBLIC OF TANZANIA


MINISTRY OF EDUCATION SCIENCE AND TECHNOLOGY


IN COLLABORATIONS WITH


PRESIDENT'S OFFICE, REGIONAL ADMINISTRATION AND LOCAL GOVERNMENT


PROVISION OF PHYSICAL FACILITIES IN PRIMARY SCHOOLS

Ministry of Education, Science and Technology Government City-Mtumba, Afya Street, P.O. Box 10, 40479 DODOMA President's Office, Regional Administration and Local Government. Government City-Mtumba, TAMISEMI Street, P.O. Box 1923, 41185 DODOMA

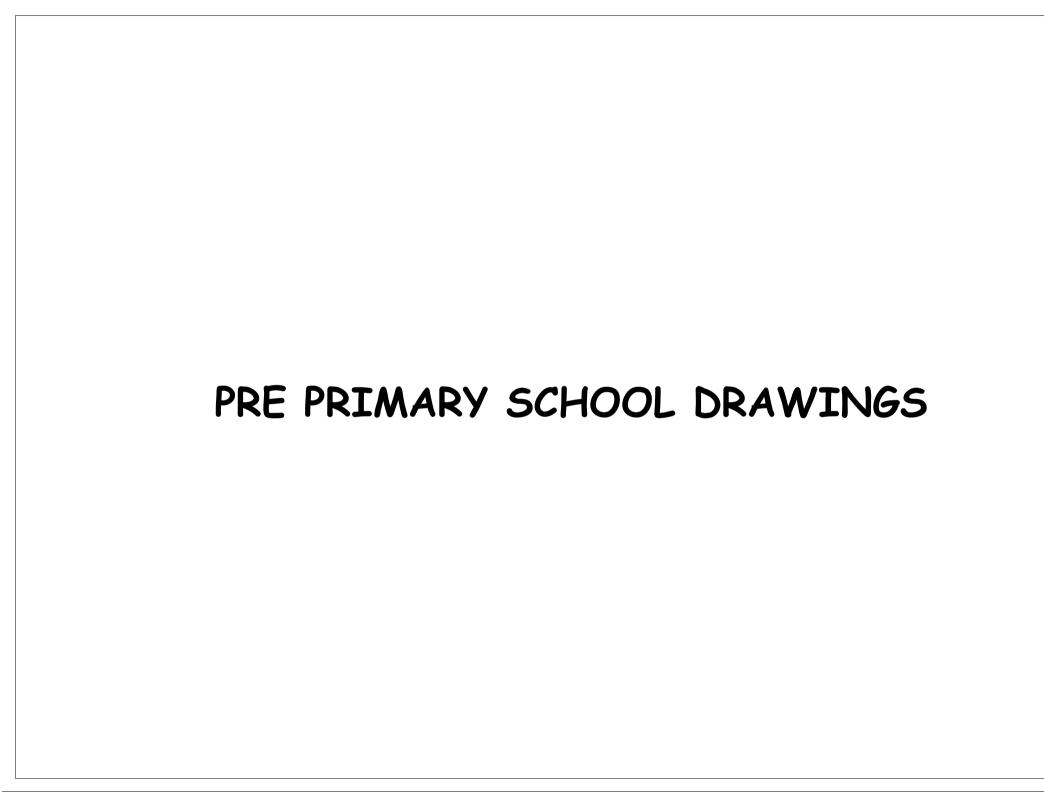


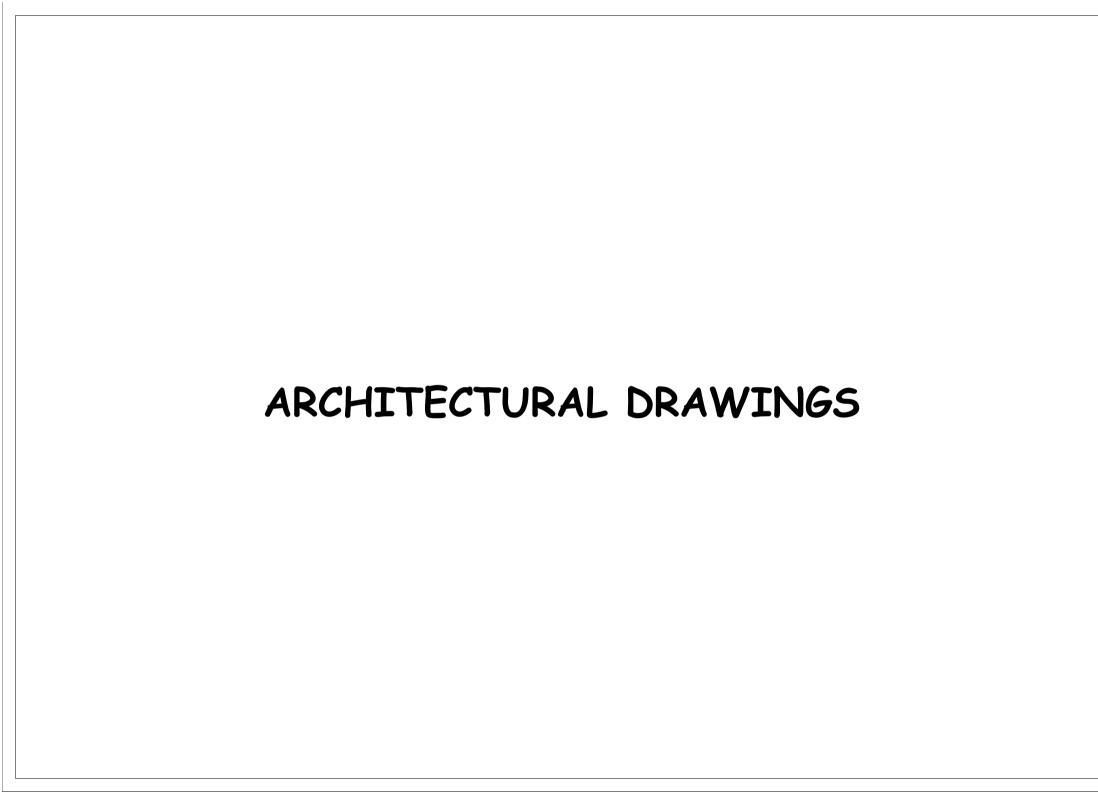

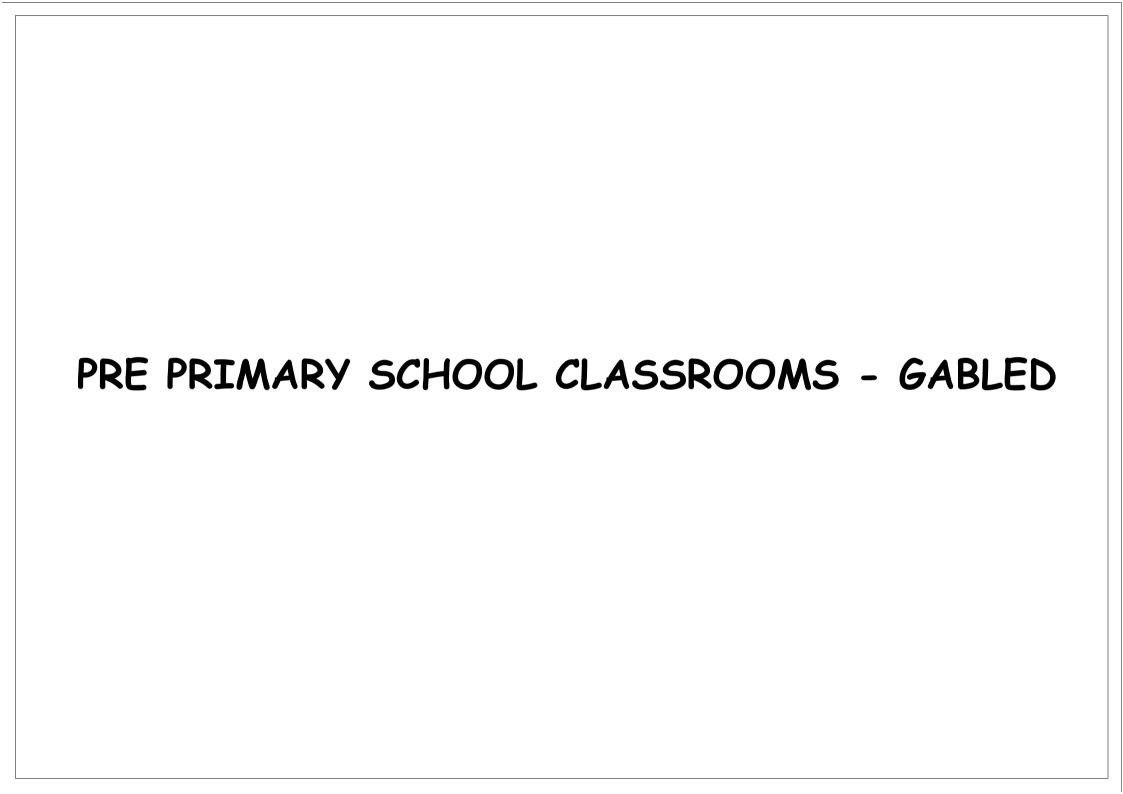

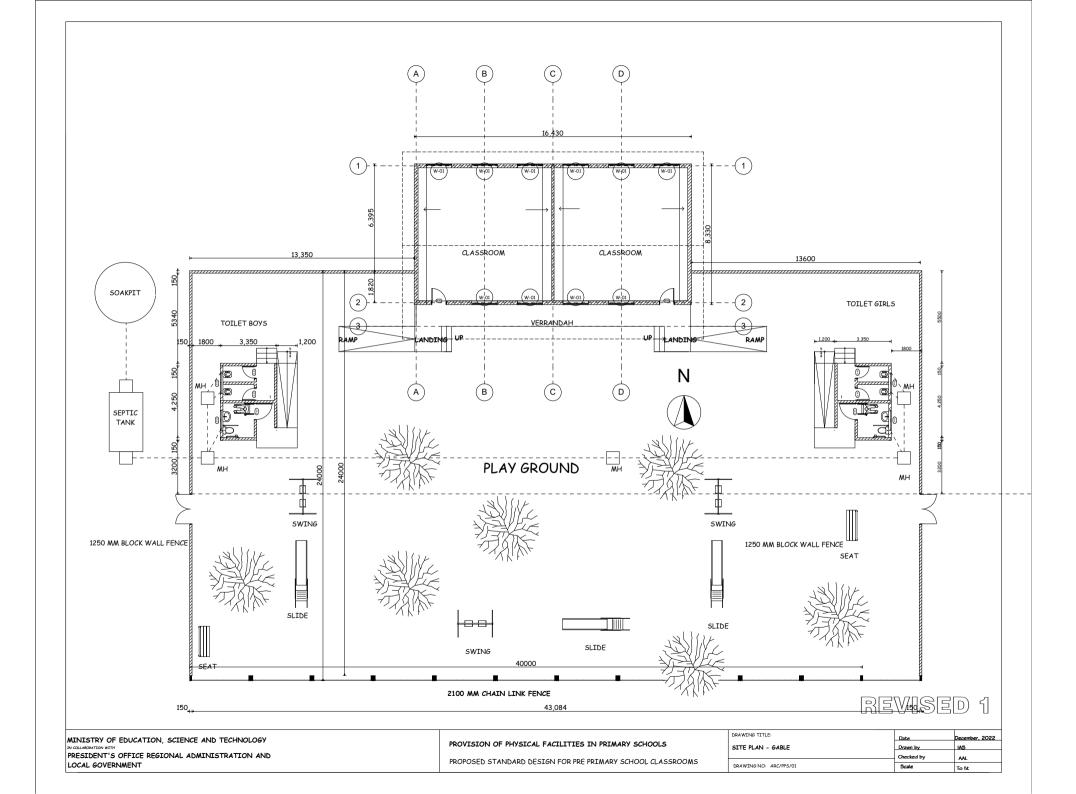

	DOOR & WI	NDOW SCHEDU	ILE					
NO.	WIDTH	HEIGHT	TOTAL	A)	(B)	(C	:
D1	900mm	2,500mm	2	→	4,050	+	4,050	4,050
W-01	1,500mm	2,000mm	10	<u> </u>		8,140	16,4 150,1	30
				230 _{+ - +}		7,910	150	•
				715	1,500 + 1,200) ₊ 1,500 ₊	1,200 1,500 1,20	00 + 1,500 + 1,2
				r -		+	 	
			(3)++	- <u> </u> <u>†</u>	HHI		- - - - - - - - -	7/ 1/

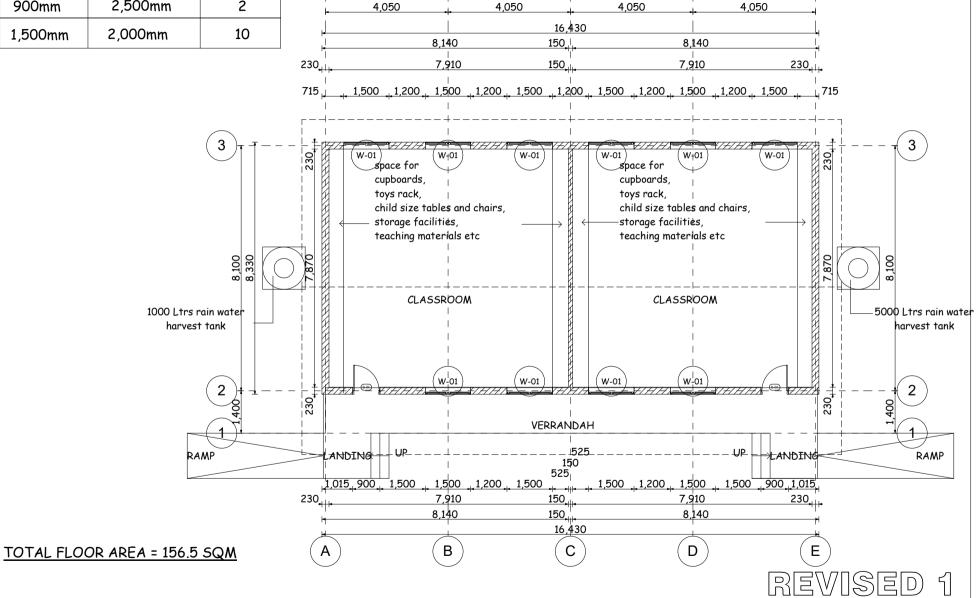

MINISTRY OF EDUCATION, SCIENCE AND TECHNOLOGY IN COLLABORATION WITH

PRESIDENT'S OFFICE REGIONAL ADMINISTRATION AND LOCAL GOVERNMENT


PROVISION OF PHYSICAL FACILITIES IN PRIMARY SCHOOLS

PROPOSED STANDARD DESIGN FOR PRE PRIMARY SCHOOL CLASSROOMS

DRAWING TITLE:

FLOOR PLAN - GABLED DRAWING NO: ARC/PPS/02 Ε

Date	December, 2022
Drawn by	IAS
Checked by	AAL
Scale	To fit

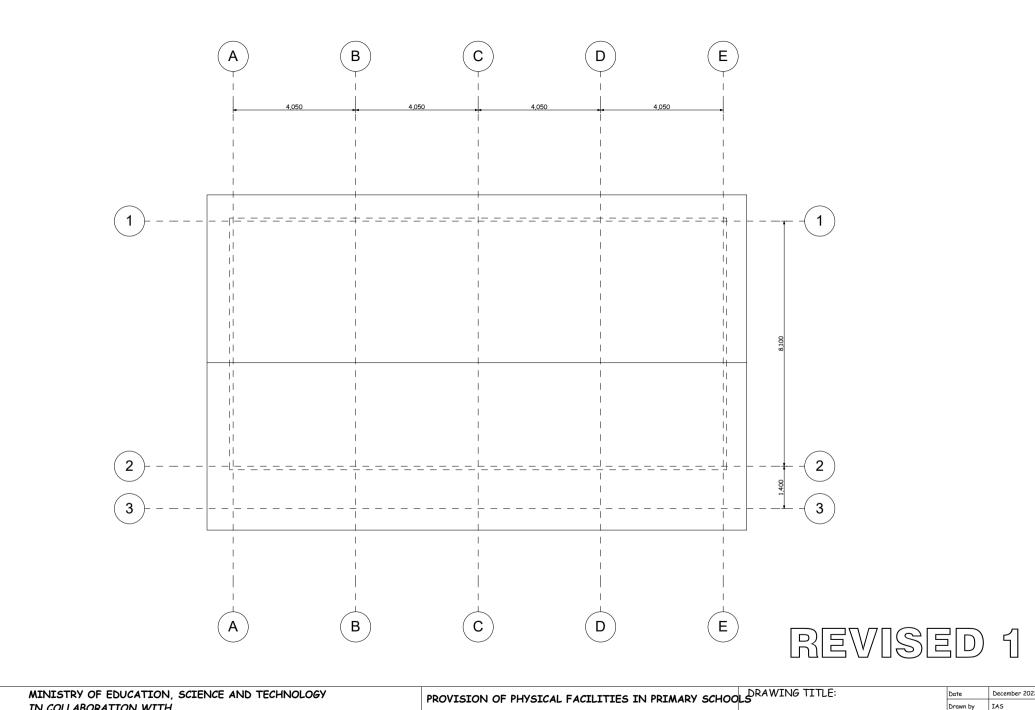


MINISTRY OF EDUCATION, SCIENCE AND TECHNOLOGY IN COLLABORATION WITH PRESIDENT'S OFFICE REGIONAL ADMINISTRATION AND LOCAL GOVERNMENT


PROPOSED STANDARD DESIGN FOR PRE PRIMARY SCHOOL CLASSROOMS

ROOF PLAN - GABLE

DRAWING NO: ARC/PPS/01

Date	December 2022
Drawn by	IAS
Checked by	AAL
Scale	To fit
1	

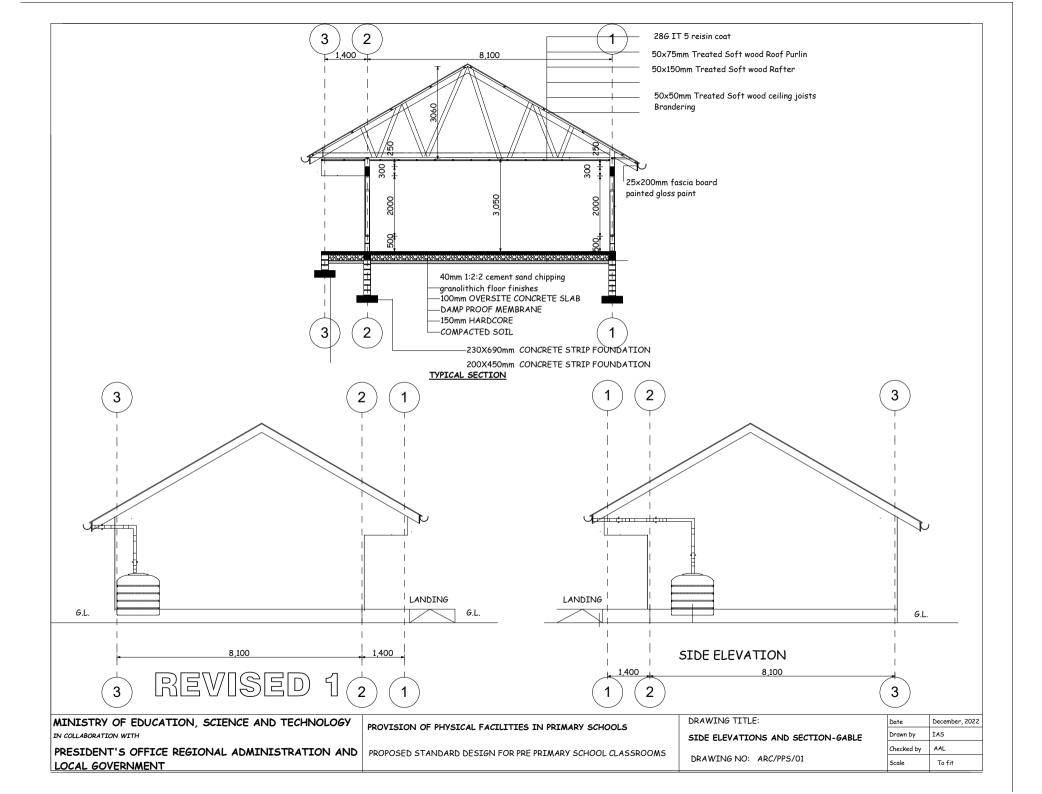


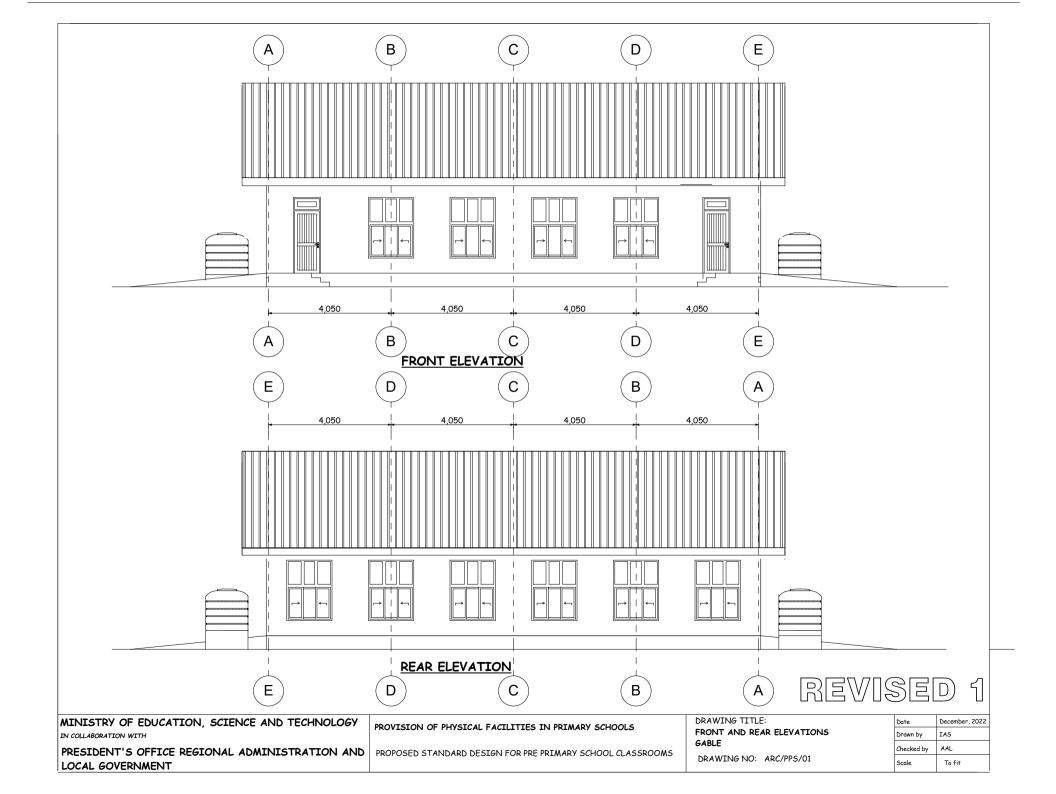



STRUCTURAL DRAWINGS


FOR


RIMARY CLASSROOM BLOCK TYPE A - 2 ROOMS - GABLE PRE-PF

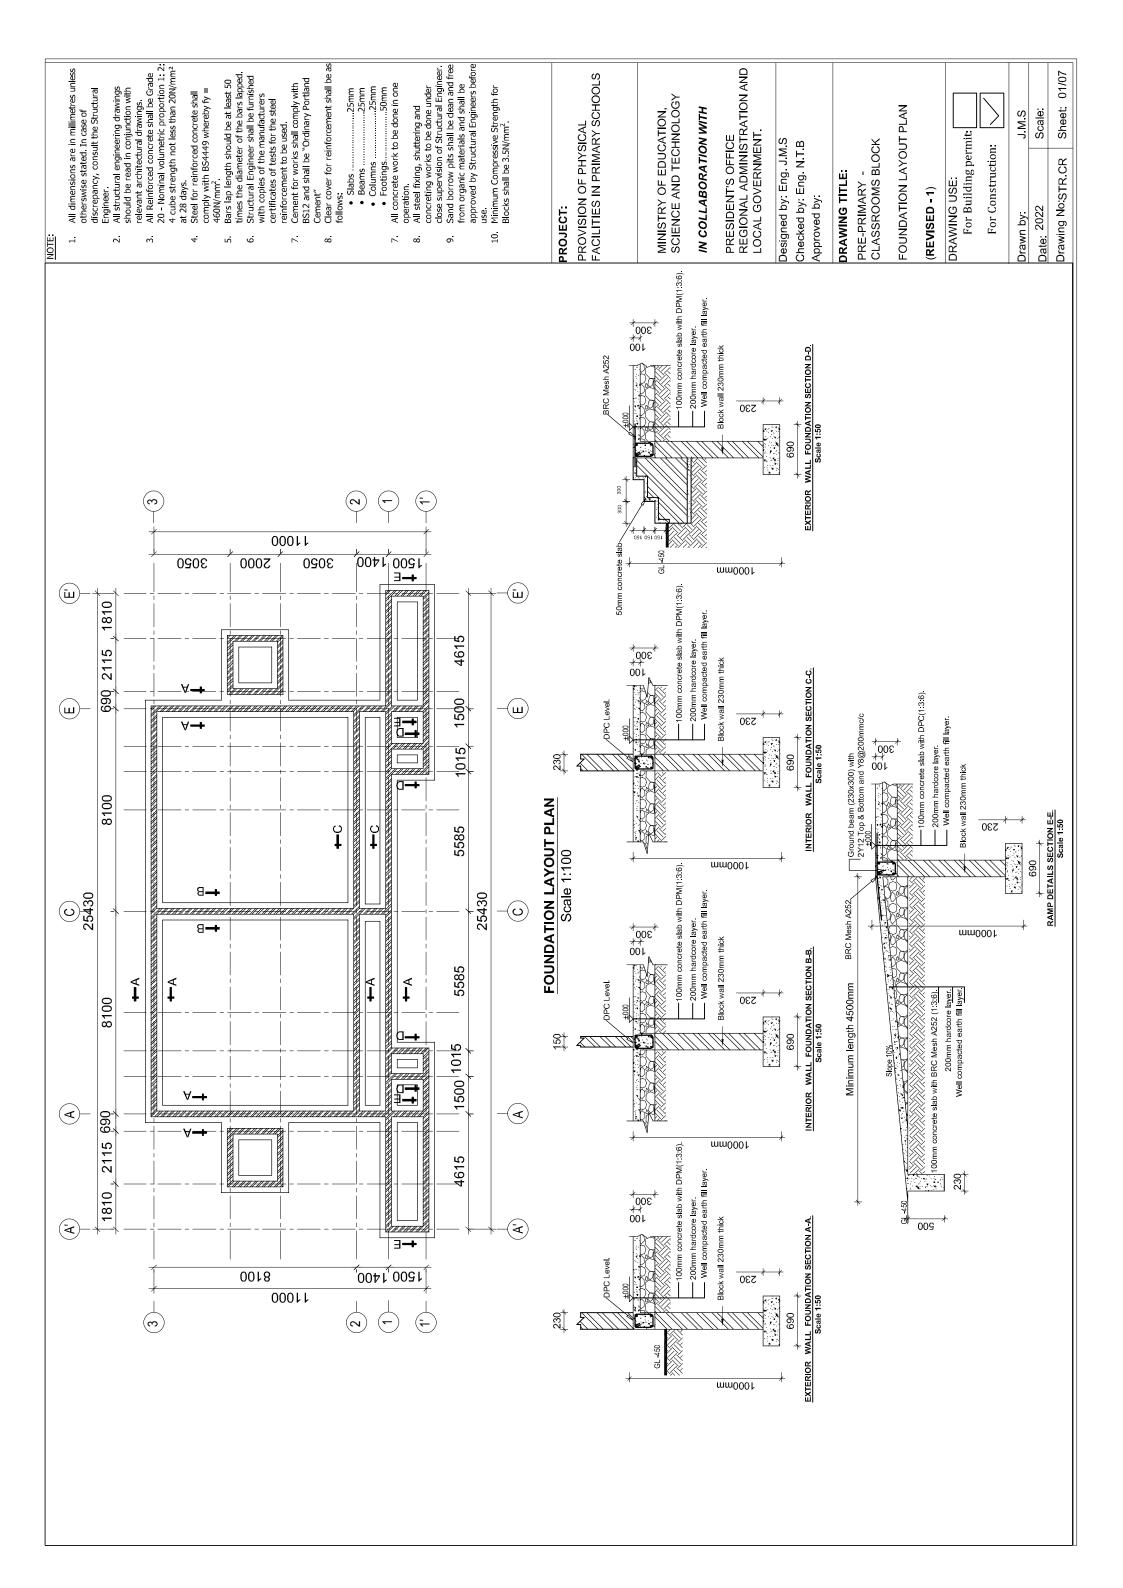


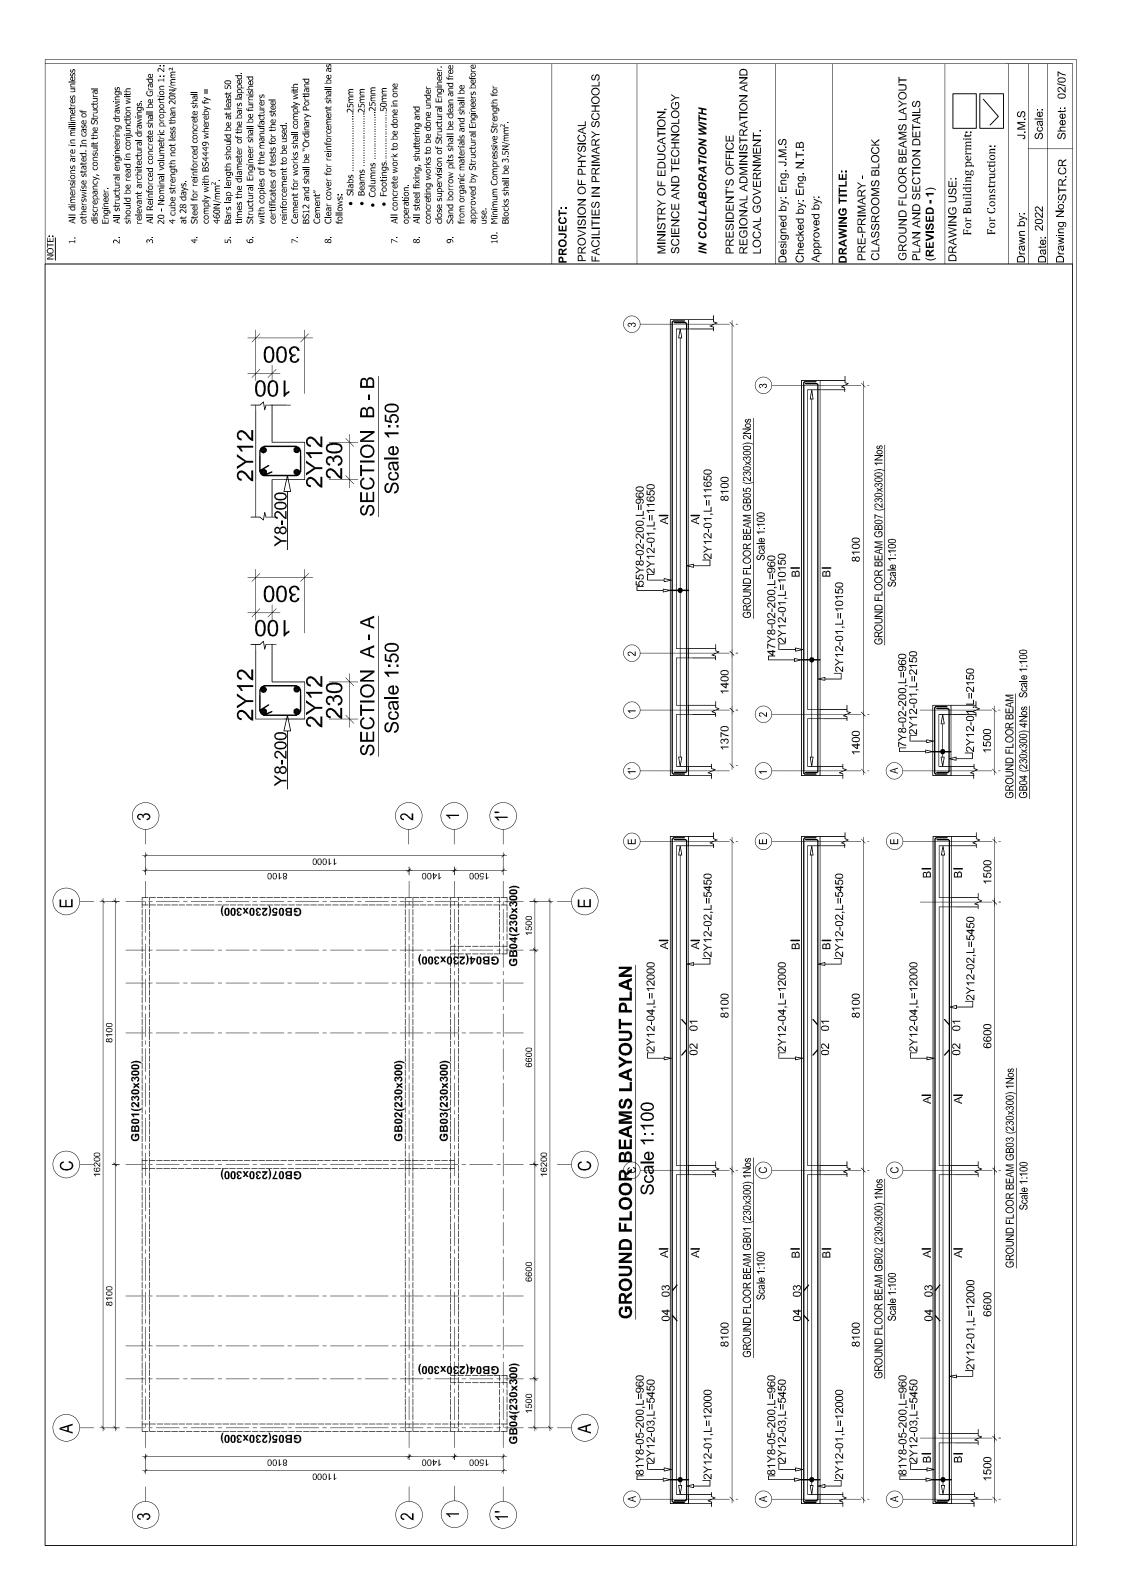

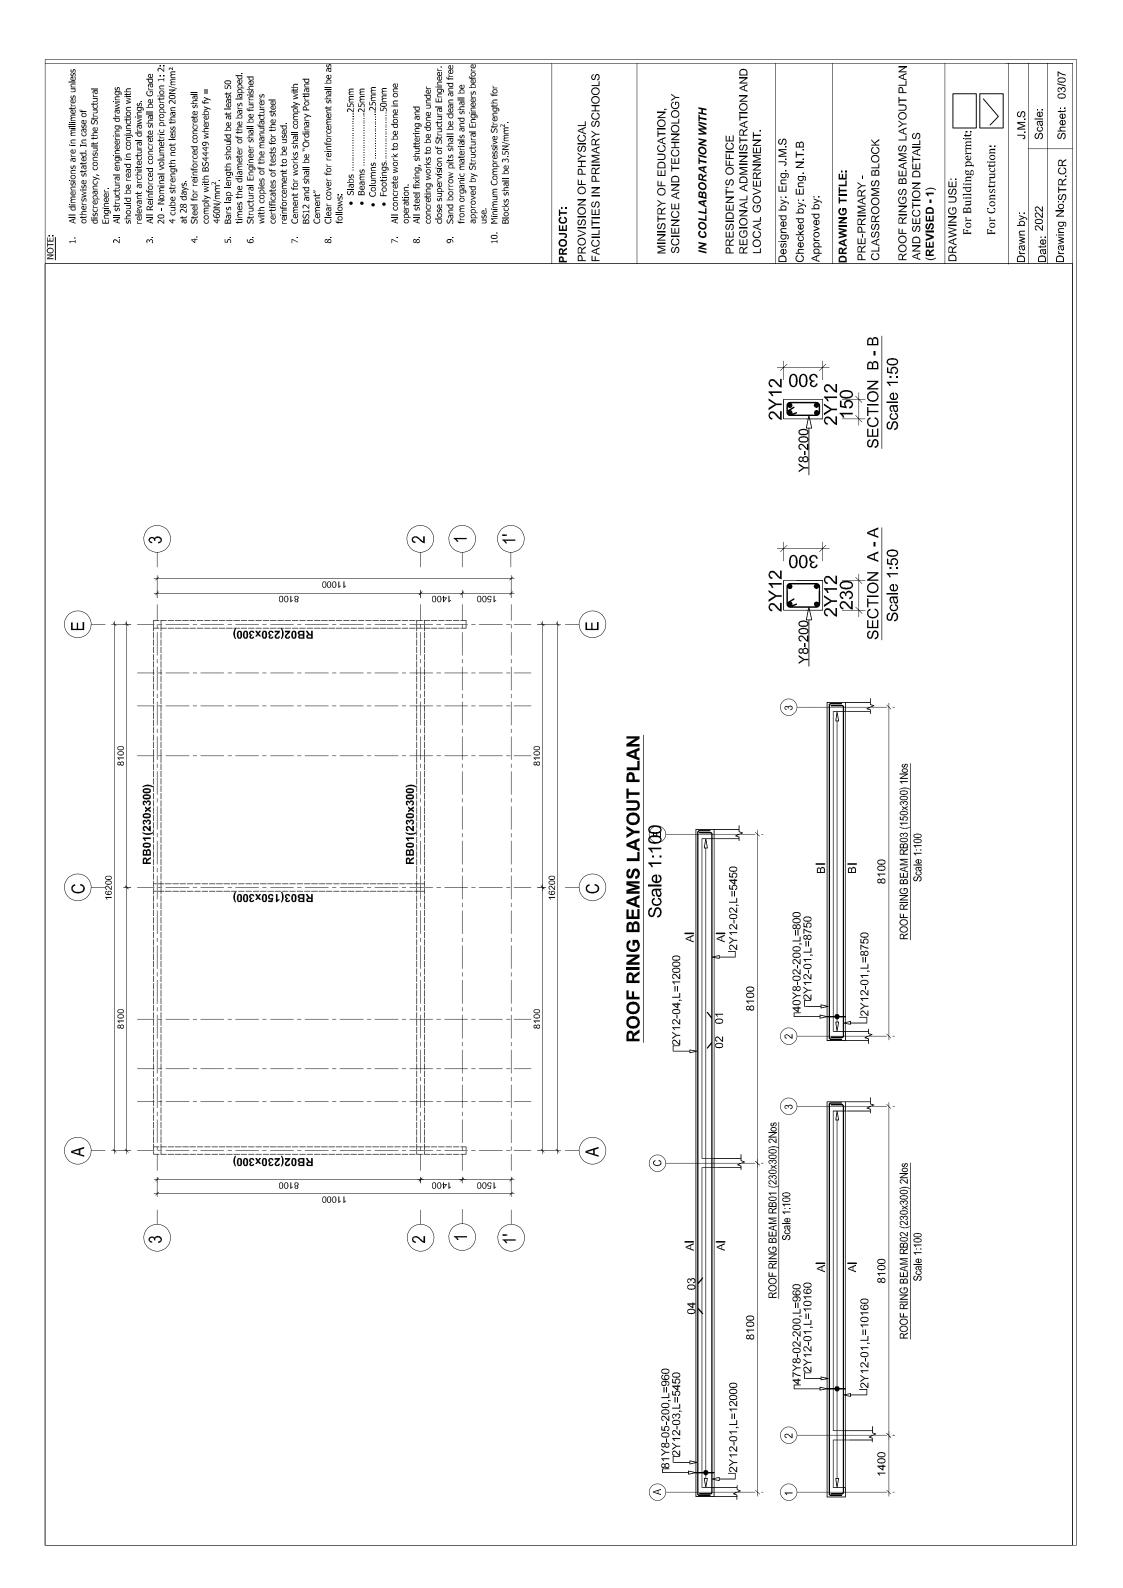

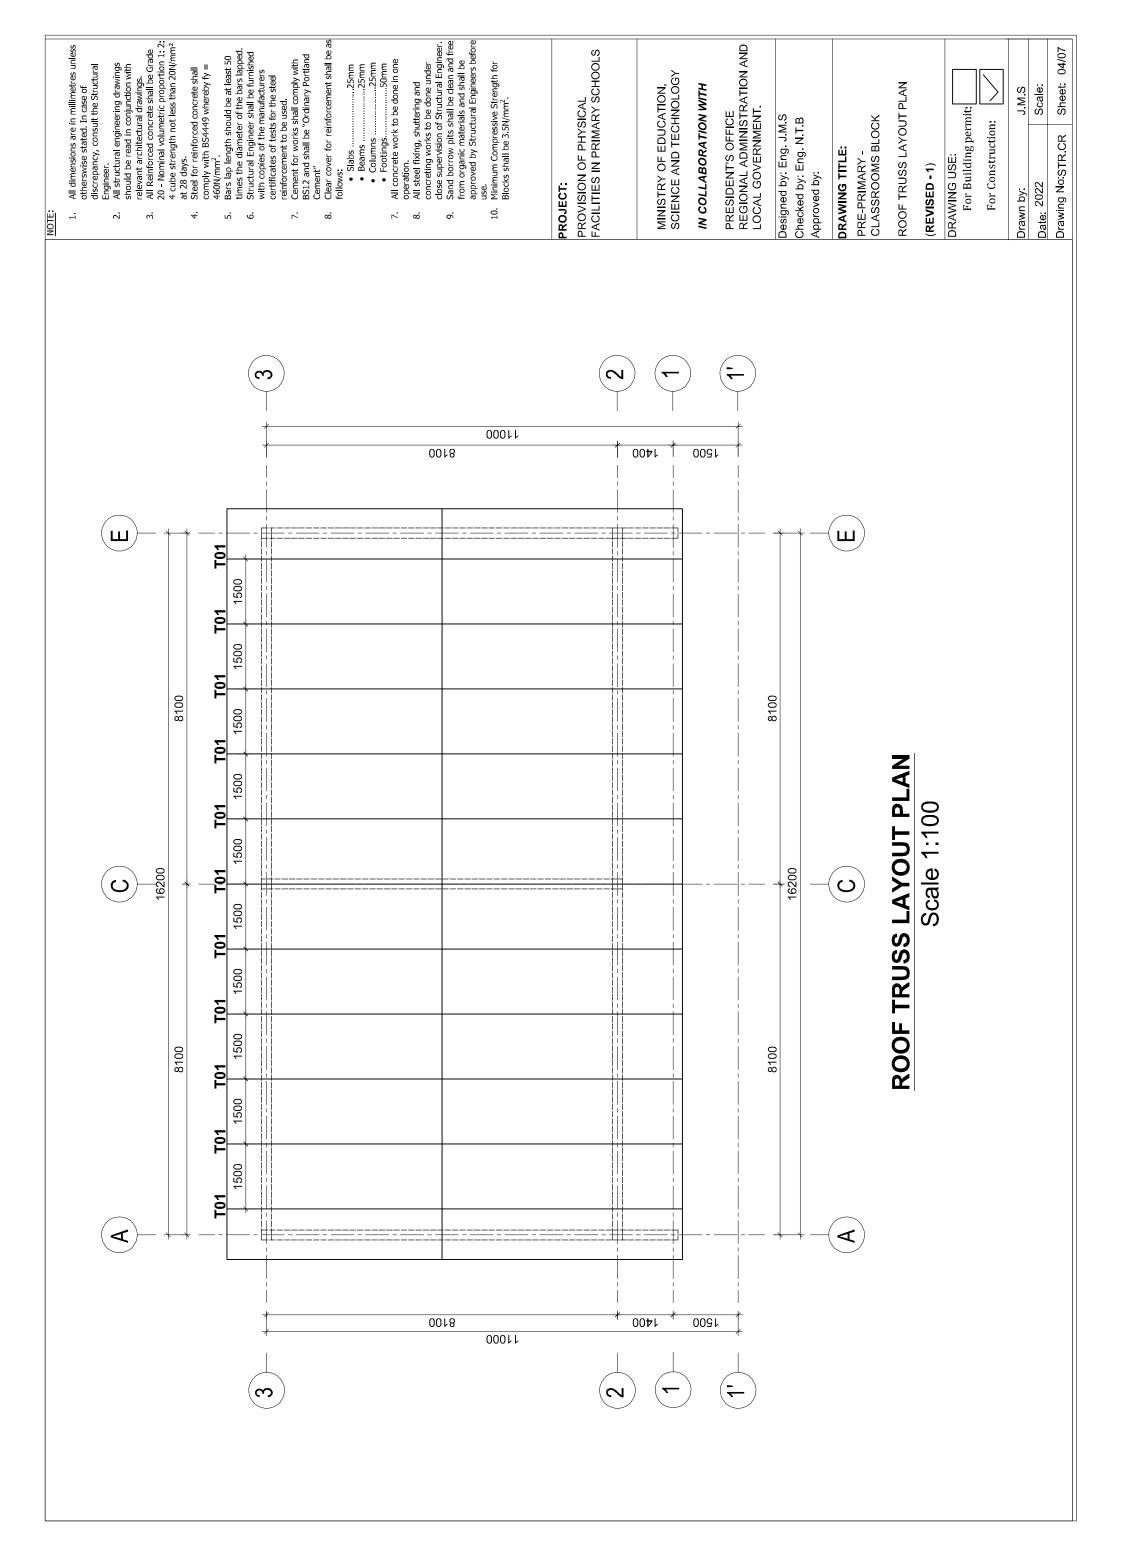

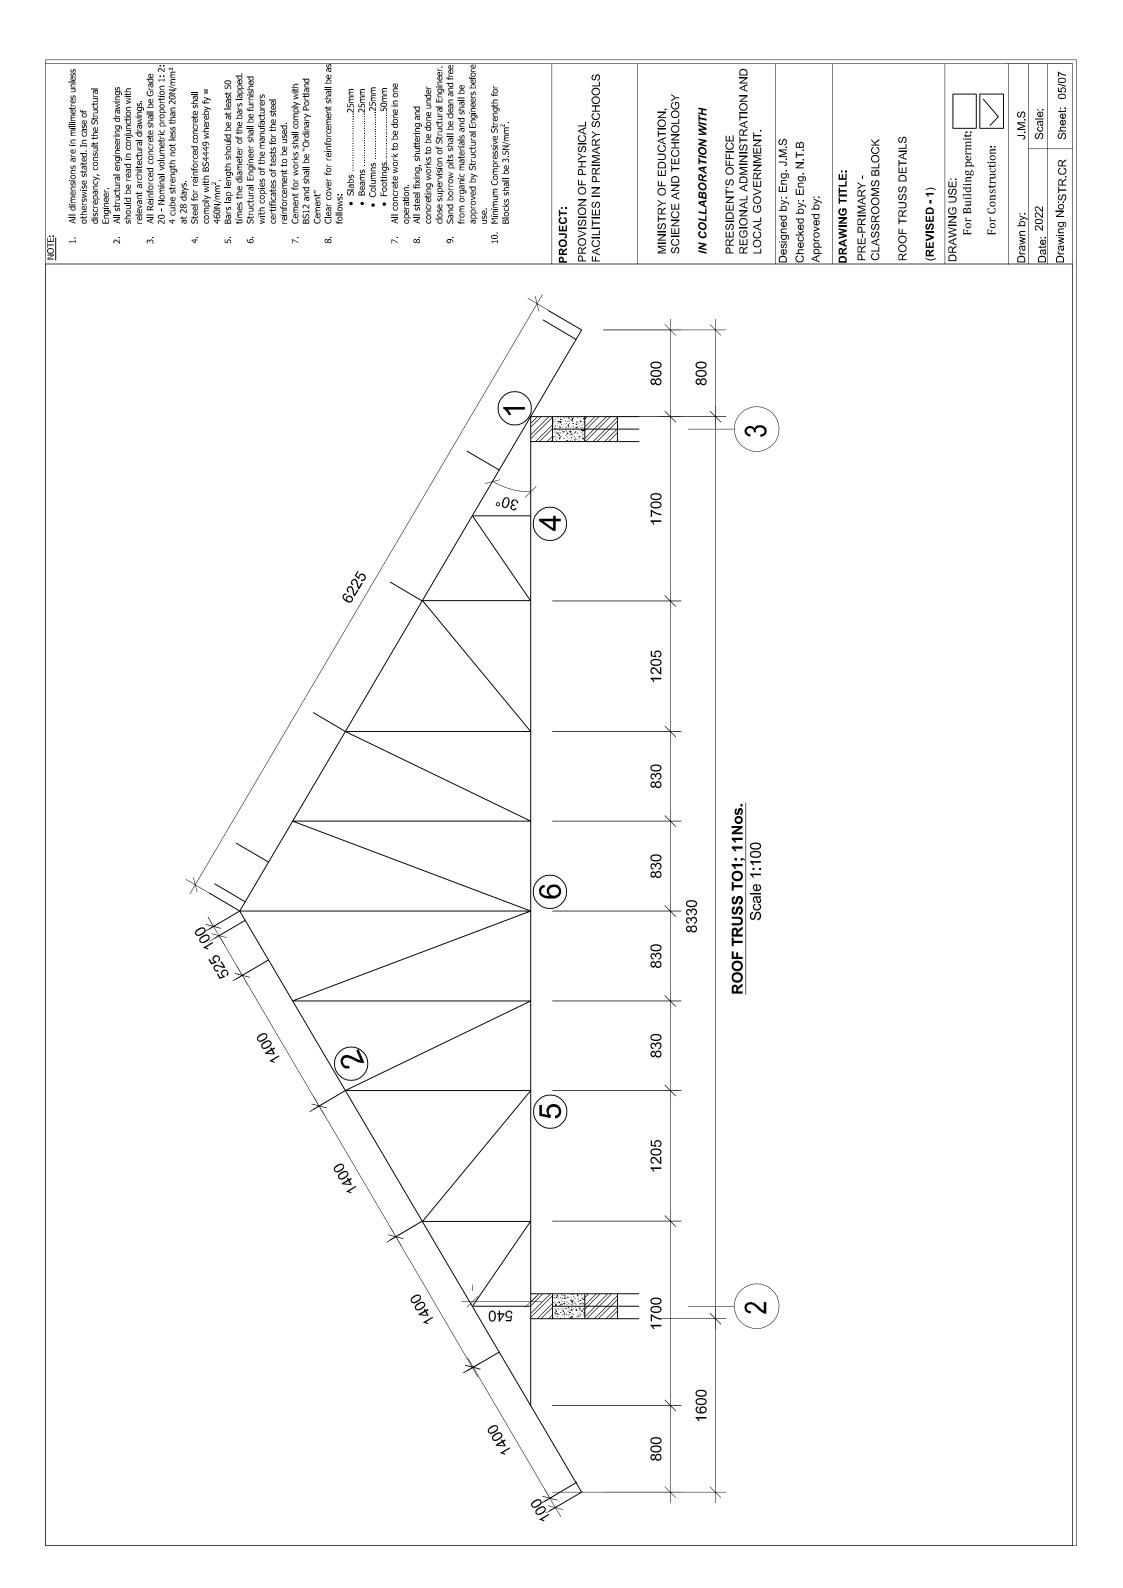

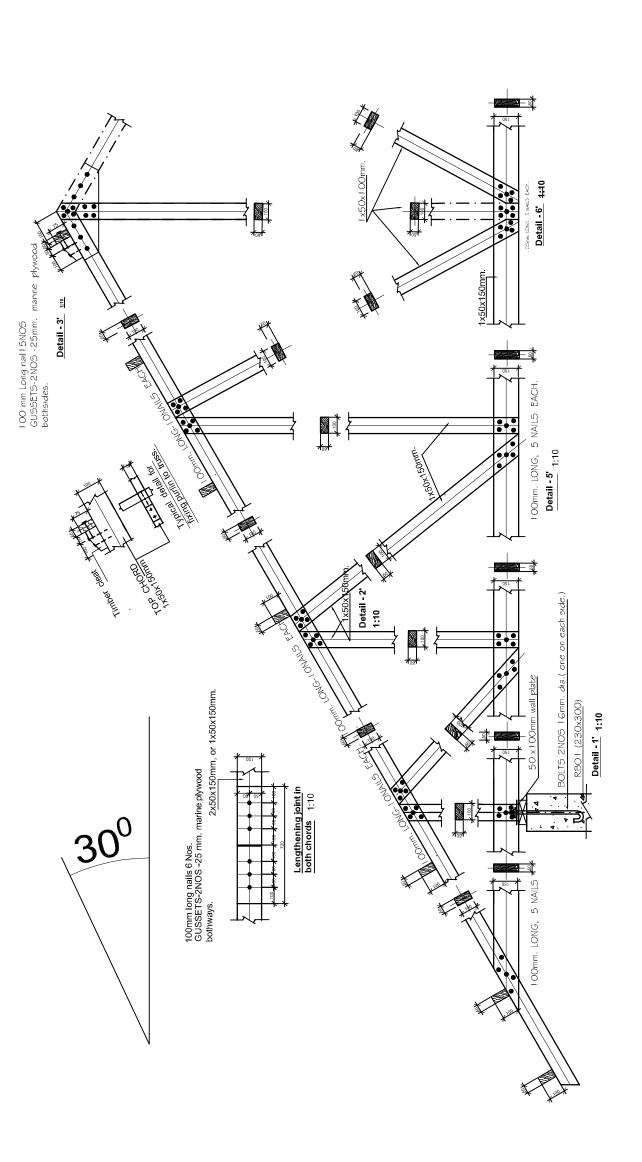

TYPICAL TRUSS CONNECTIONS DETAIL

- All dimensions are in millimetres unless otherswise stated. In case of discrepancy, consult the Structural
- All structural engineering drawings should be read in conjunction with relevant architectural drawings.

 All Reinforced concrete shall be Grade 20 Nominal volumetric proportion 1: 2: 4 cube strength not less than 20N/mm² at 28 days.

 Steel for reinforced concrete shall comply with BS4449 whereby fy = 460N/mm².
- Ŋ
- Bars lap length should be at least 50 times the diameter of the bars lapped. Structural Engineer shall be furnished with copies of the manufacturers certificates of tests for the steel reinforcement to be used. Cement for works shall comply with BS12 and shall be "Ordinary Portland Cement".
 - - .25mm Slabs
- 7 ω.
- - use. Minimum Compressive Strength for Blocks shall be 3.5N/mm². 9

PROJECT:

PROVISION OF PHYSICAL FACILITIES IN PRIMARY SCHOOLS

MINISTRY OF EDUCATION, SCIENCE AND TECHNOLOGY

IN COLLABORATION WITH

PRESIDENT'S OFFICE
REGIONAL ADMINISTRATION AND
LOCAL GOVERNMENT.

Designed by: Eng. J.M.S Checked by: Eng. N.T.B. Approved by:

DRAWING TITLE:

PRE-PRIMARY -CLASSROOMS BLOCK

ROOF TRUSS CONNECTION DETAILS (REVISED - 1)

DRAWING USE

CAVVIIVE COFF.	For Building permit	For Construction:

Drawn by:	JMS
Date: 2022	Scale:
Drawing No:STR.CR	Sheet: 06/07

		NUMBER OF MEMBER	8	Ø	Ø	2	7	8	5		1														
!	Page 2/2	MEMBER TYPE	ROOF BEAM 1	ROOF BEAM 1	ROOF BEAM 1	ROOF BEAM 1	ROOF BEAM 1	ROOF BEAM 2	ROOF BEAM 2	ROOF BEAM 3	ROOF BEAM 3														
					•																				
		NOTES																							
	GOOMS BLOCK	SKETCH OF BAR DIMENSIONS IN (mm)	11750	10921	00000000000000000000000000000000000000	11750	180 NSO	11750 06S1	10971	2500	11750	180 200	11750	10971	900 1000 1000 1000 1000 1000 1000 1000	11750	50 50 180 180	1650 RED +	180 081	1000	50 50 180 180 180 180 180 180 180 180 180 18	1 0921	180 500 F		
	PROVISION OF PHYSICAL FACILITIES FOR PRIMARY SCHOOLS - PRE-PRIMARY CLASSROOMS BLOCK (GROUND FLOOR BEAMS)	TOTAL LENGTH (m)	- 24	10.9	10.9	- 24	97.77	24	-	10.9	- 24	97.77	- 24	10.9	- 6.01	- 24	77.76	34.4	26.88	- 26	105.6	40.6	45.12		
Schedule	MARY SCHOOLS FLOOR BEAMS	NO.OF BARS	Ø	Ø	01	8	81	Ø	Ø	2	8	18	2	Ø	2	Ø	81	16	28	60	110	4	47		
Bar Bending Schedule	ACILITIES FOR PRIN	LENGTH OF EACH BAR (mm)	12000	5450	5450	12000	096	12000	5450	5450	12000	096	12000	5450	5450	12000	096	2150	096	11500	096	10150	096		
	N OF PHYSICAL FA	BAR TYPE AND SIZE (mm)	Y12	Y12	Y12	Y12	Υ8	Y12	Y12	Y12	Y12	γ8	Y12	Y12	Y12	Y12	γ8	Y12	٧8	Y12	٧8	Y12	Υ8		
	PROVISIC	MARK No.	10	02	03	04	05	10	02	03	04	05	10	02	03	04	05	01	02	10	05	10	05		
		NUMBER OF MEMBER	-	-	-	-	-	-	-	+	-	-	٢	-	-	-	-	4	4	Ø	61	F	-		
	Page 1/2	MEMBER TYPE	GROUND BEAM1	GROUND BEAM 1	GROUND BEAM 1	GROUND BEAM 1	GROUND BEAM 1	GROUND BEAM2	GROUND BEAM2	GROUND BEAM2	GROUND BEAM2	GROUND BEAM2	GROUND BEAM3	GROUND BEAM3	GROUND BEAM3	GROUND BEAM3	GROUND BEAM3	GROUND BEAM 4	GROUND BEAM 4	GROUND BEAM 5	GROUND BEAM 5	GROUND BEAM 6	GROUND BEAM6		

		NOTES																	
	SROOMS BLOCK	SKETCH OF BAR DIMENSIONS IN (mm)	11750	10921	00025	11/250	500 + S00 +	10921	2005 N N 180	1 097	1057 1000 1000 1000 1000 1000 1000 1000								
ø	PROVISION OF PHYSICAL FACILITIES FOR PRIMARY SCHOOLS - PRE-PRIMARY CLASSROOMS BLOCK (ROOF RING BEAMS)	TOTAL LENGTH (m)	48	21.8	21.8	48	155.52	81.28	90.24	35	32								
Schedul	MARY SCHOOL FING BEAMS)	NO.OF BARS	4	4	4	4	162	80	94	4	40								
Bar Bending Schedule	ACILITIES FOR PRII	LENGTH OF EACH BAR (mm)	12000	5450	5450	12000	096	10160	096	8750	800								
	ON OF PHYSICAL F	BAR TYPE AND SIZE (mm)	Y12	Y12	Y12	Y12	Y8	Y12	٧8	Y12	٧8								
	PROVISIO	MARK No.	10	002	03	04	90	10	02	10	02								
		NUMBER OF MEMBER	8	Ø	a	2	2	2	2	r =									
	rage z/z	EMBER TYPE	100F BEAM 1	SOOF BEAM 1	SOOF BEAM 1	300F BEAM 1	300F BEAM 1	300F BEAM 2	300F BEAM 2	ROOF BEAM 3	ROOF BEAM 3								

NOTE:

- All dimensions are in millimetres unless otherswise stated. In case of discrepancy, consult the Structural Engineer.

 All structural engineering drawings should be read in conjunction with relevant architectural drawings.

 All Reinforced concrete shall be Grade 20 Nominal volumetric proportion 1: 2: 4 cube strength not less than 20N/mm² at 28 days.

 Steel for reinforced concrete shall comply with BS449 whereby fy = 460N/mm².

 Bars lap length should be at least 50 times the diameter of the bars lapped. Structural Engineer shall be furnished with copies of the manufacturers certificates of tests for the steel reinforcement to be used.

 Cement for works shall comply with BS12 and shall be "Ordinary Portland Cement".

 Clear cover for reinforcement shall be as follows: 7 m
 - 4
 - 5 9
- 7

- 7 œ
- 6
 - 10

PROJECT:

PROVISION OF PHYSICAL FACILITIES IN PRIMARY SCHOOLS

MINISTRY OF EDUCATION, SCIENCE AND TECHNOLOGY

PRESIDENT'S OFFICE REGIONAL ADMINISTRATION AND LOCAL GOVERNMENT. IN COLLABORATION WITH

Designed by: Eng. J.M.S Checked by: Eng. N.T.B

Approved by:

DRAWING TITLE:

PRE-PRIMARY -CLASSROOMS BLOCK

GROUND FLOOR BEAMS AND ROOF RING BEAMS BAR BENDING SCHEDULES (**REVISED - 1**)


DRAWING USE:	For Building permit	
DRAWIN	For	


<u></u>	J.M.S	
For Construction:	Drawn by:	


Scale:	Sheet: 07/07
Date: 2022	Drawing No.STR.CR

	Bar Bending Schedule								
Page 1/2	PROVISION OF PHYSICAL FACILITIES FOR PRIMARY SCHOOLS - PRE-PRIMARY CLASSROOMS BLOCK (GROUND FLOOR BEAMS)								
MEMBER TYPE	NUMBER OF MEMBER	MARK No.	BAR TYPE AND SIZE (mm)	LENGTH OF EACH BAR (mm)	NO.OF BARS	TOTAL LENGTH (m)	SKETCH OF BA DIMENSIONS I (mm)		NOTES
GROUND BEAM 1	1	01	Y12	12000	2	24	11750		
GROUND BEAM 1	1	02	Y12	5450	2	10.9	5200	1250+	
GROUND BEAM 1	1	03	Y12	5450	2	10.9	5200 092		
GROUND BEAM 1	1	04	Y12	12000	2	24	11750	1250+	
GROUND BEAM 1	1	05	Y8	960	81	77.76	50 50 000 180	-	
GROUND BEAM 2	1	01	Y12	12000	2	24	11750		
GROUND BEAM 2	1	02	Y12	5450	2	10.9	5200	1250+	
GROUND BEAM 2	1	03	Y12	5450	2	10.9	5200 00 00 00		
GROUND BEAM 2	1	04	Y12	12000	2	24	11750	1250+	
GROUND BEAM 2	1	05	Y8	960	81	77.76	50 50 20 180	-	
GROUND BEAM 3	1	01	Y12	12000	2	24	11750		
GROUND BEAM 3	1	02	Y12	5450	2	10.9	5200	1250+	
GROUND BEAM 3	1	03	Y12	5450	2	10.9	5200 000 000 000		
GROUND BEAM 3	1	04	Y12	12000	2	24	11750	1250+	
GROUND BEAM 3	1	05	Y8	960	81	77.76	50 50 27 180	-	
GROUND BEAM 4	4	01	Y12	2150	16	34.4	1650	1250	
GROUND BEAM 4	4	02	Y8	960	28	26.88	50 50 50 180	-	
GROUND BEAM 5	2	01	Y12	11500	8	92	11000	1250	
GROUND BEAM 5	2	02	Y8	960	110	105.6	50 50 092 180		
GROUND BEAM 6	1	01	Y12	10150	4	40.6	9650	1250	
GROUND BEAM 6	1	02	Y8	960	47	45.12	50 50 00 180	-	

Po~~ 0/0				Bar Bendin	g Schedul	e 			
Page 2/2	PROVISION OF PHYSICAL FACILITIES FOR PRIMARY SCHOOLS - PRE-PRIMARY CLASSROOMS BLOCK (ROOF RING BEAMS)								
MEMBER TYPE	NUMBER OF MEMBER	MARK No.	BAR TYPE AND SIZE (mm)	LENGTH OF EACH BAR (mm)	NO.OF BARS	TOTAL LENGTH (m)	SKETCH OF B. DIMENSIONS (mm)		NOTES
ROOF BEAM 1	2	01	Y12	12000	4	48	11750		
ROOF BEAM 1	2	02	Y12	5450	4	21.8	5200	1550+	
ROOF BEAM 1	2	03	Y12	5450	4	21.8	5200 095 201		
ROOF BEAM 1	2	04	Y12	12000	4	48	11750	1550	
ROOF BEAM 1	2	05	Y8	960	162	155.52	50 50 50 00 180		
ROOF BEAM 2	2	01	Y12	10160	8	81.28	9660	1250	
ROOF BEAM 2	2	02	Y8	960	94	90.24	50 - 50 05 1180	-	
ROOF BEAM 3	1	01	Y12	8750	4	35	8250	1250	
ROOF BEAM 3	1	02	Y8	800	40	32	50 _ 50 Q _X	-	
							+		

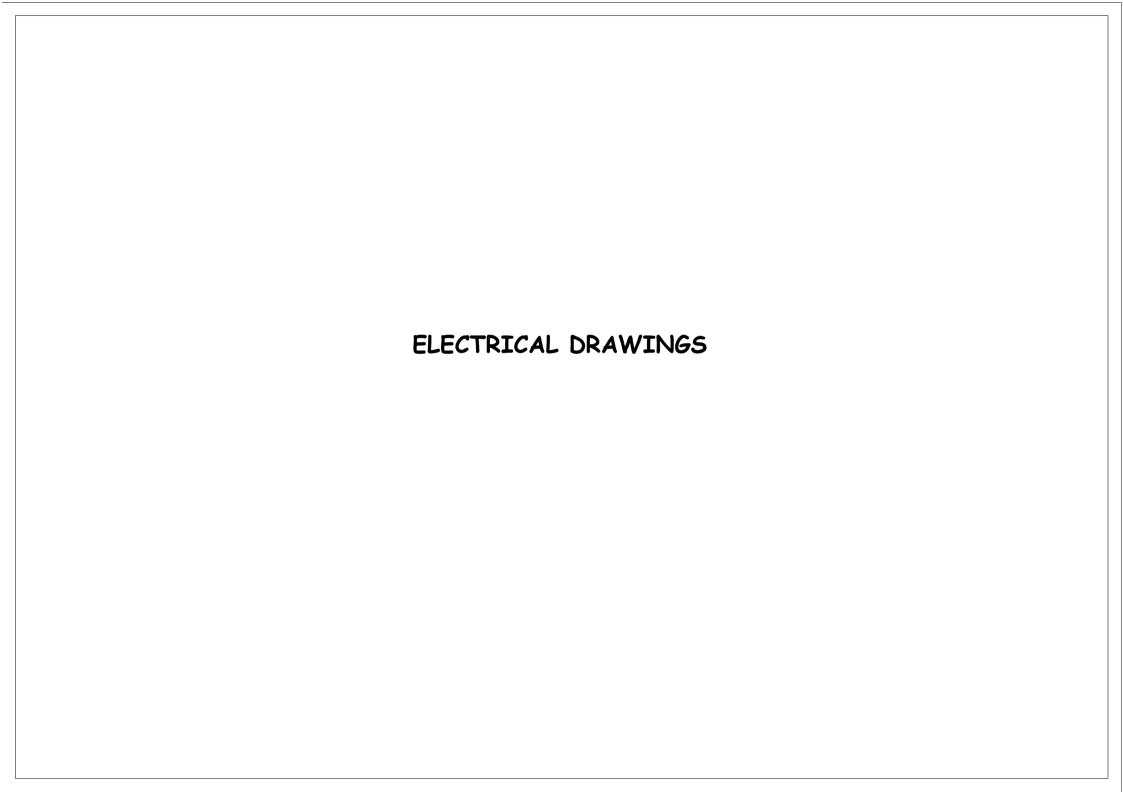

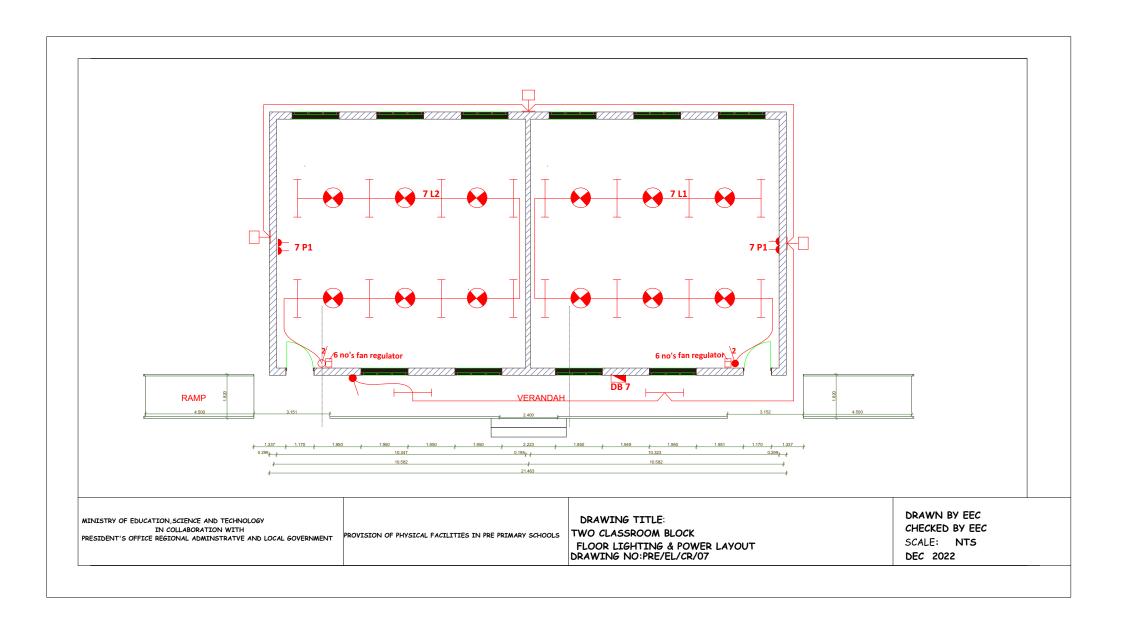

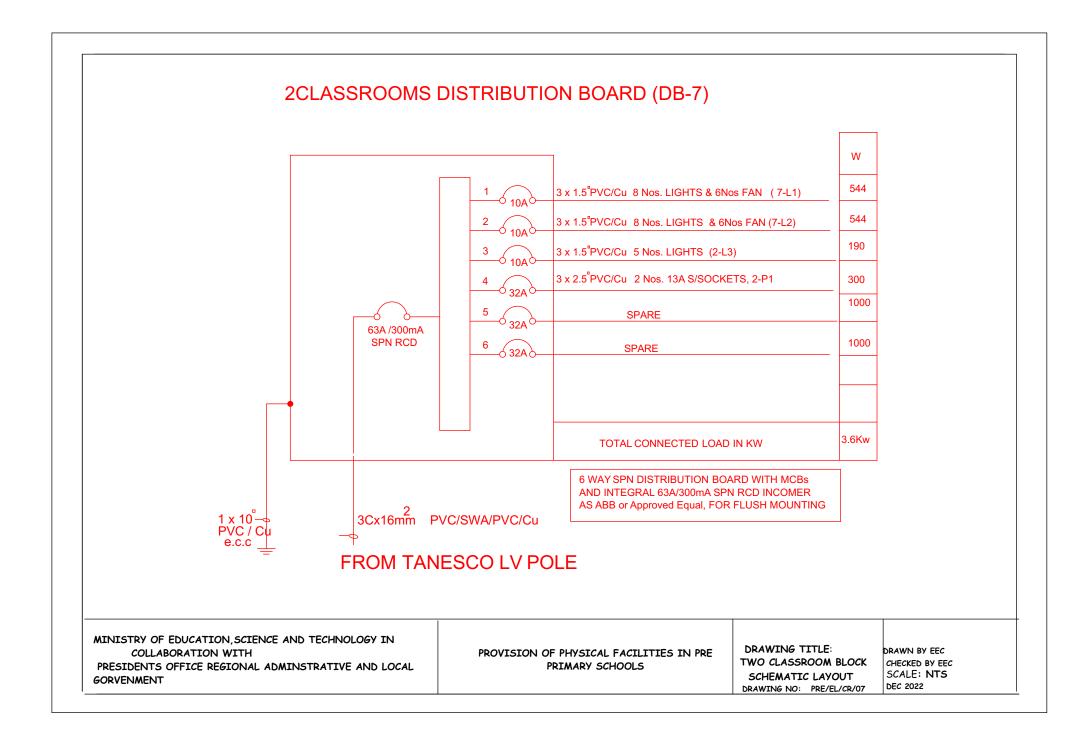

KEY TO SYMBOLS

SYMBOL	DESCRIPTION	MOUNTING HEIGHT
	Distribution Board with integral RCD	2000 mm AFFL
Н	Bulkhead light Fitting	Wall Mounted
 	4FT Single Electronic Start Fluorecent Light	On Ceilling
	Ceilling Fan	On Ceilling
	Fan Regulator	1500 mm AFFL
	1 gang 1way Switch	1500 mm AFFL
4	1 gang 2way Switch	1500 mm AFFL
42	2 gang 2way Switch	1500 mm AFFL
3	3 gang 1way Switch	
2	2 gang 1way Switch	1500 mm AFFL
<u>\</u>	4 gang 1way Switch	1500 mm AFFL
	Twin Switch Socket	450 mm AFFL
C	Ceilling light complete with energy saver 11w	on level

MINISTRY OF EDUCATION, SCIENCE AND TECHNOLOGY IN
COLLABORATION WITH
PRESIDENTS OFFICE REGIONAL ADMINSTRATIVE AND LOCAL
GORVENMENT

PROVISION OF PHYSICAL FACILITIES IN PRE PRIMARY SCHOOLS DRAWING TITLE: THREE CLASSROOM BLOCK LEGEND

DRAWING NO: P/EL/CR/07

DRAWN BY EEC
CHECKED BY EEC
SCALE: NTS
DEC 2022